DEVELOPMENT APPLICATION

GENERAL ABBREVIATIONS

- AC OUTDOOR AIR CONDITIONING UNIT ADJ ADJACENT
- BL BOLLARD LIGHT
 BO BALCONY OUTLET
- CONC CONCRETE
- CONC CONCRETE
 COL COLUMN
 CJ CONTROL JOINT
- DP DOWNPIPE DW DISH WASHER
- DWR DRAW

 EGL EXISTING GROUND LINE
- EXT FIRE EXTINGUISHER
- FCL FINISHED CEILING LEVEL FINISHED FLOOR LEVEL
- FG FIXED GLASS
- FGL FINISHED GROUND LINE FHR FIRE HOSE REEL
- FIP FIRE INDICATOR PANEL FR REFRIDGERATER
- FSL FINISHED SLAB LEVEL
- GPO GENERAL PURPOSE OUTLET
- HC HOSE COCK HD HAND DRYER
- HD HAND DRYER HR HANDRAIL
- HWS HOT WATER SYSTEM
- LP LIGHT POLE
- NGL NATURAL GROUND LINE
- OVR OVERFLOW
- P PANTRY
- PB1,2... PLASTERBOARD TYPE 1,2 ECT.
 PBO PLANTER BOX OUTLET
- PP ELECTRICITY POWER POLE
 POE ELECTRICAL POINT OF ENTRY
- RL RELATIVE LEVEL RWH RAIN WATER HEAD
- RWO RAIN WATER OUTLET
- SD SOAP DISPENSER SKT SKIRTING
- SSL STRUCTURAL SLAB LEVEL
- SMH SEWER MANHOLE
- SWMH STORM WATER MANHOLE
- TRH TOILET ROLL HOLDER TOW TOP OF WALL LEVEL

DESCRIPTION CONCEPT ISSUE REVISED CONCEPT ISSUE DA DRAFT ISSUE CONSULTANT ISSUE DA ISSUE DA ISSUE

DATE
26.05.24
20.12.24
21.04.25
06.07.25
05.08.25
19.08.25

This drawing is to be read in conjunction with all other contract documents inclusive of all schedules, specifications and other consultants documentation. Any discrepancies or inconsistencies are to be clarified prior to works. Written dimensions take precedence over scaled dimensions. This drawing is copyright and shall remain the property of Kensit Architects.

SHOPTOP HOUSING

5/-/DP778947 [187 BOURKE ST GOULBURN]

DA 000 COVER SHEET

DA 001 SITE ANALYSIS / EXISTING CONDITIONS

DA 002 EXISTING SITE PLAN
DA 004 DEMOLITION SITE PLAN

DA 010 PROPOSED SITE PLAN

DA 100 FLOOR PLANS
DA 101 ROOF PLAN

DA 102 AREA PLANS

DA 200 ELEVATIONS

DA 201 STREETSCAPE

MATERIAL SAMPLE BOARD
SECTIONS

DA 400 BASIX REQUIREMENTS

DA 401 BASIX REQUIREMENTS

DA 500 SHADOW DIAGRAMS

DA 501 SOLAR ACCESS



DRAWING No.

DRAWING TITLE

SCALE

DATE

AUGUST 2025

5/-/DP778947 [187 BOURKE ST GOULBURN]

SCALE NTS

DATE AUGUST 2025

202405

PROJECT No.

DEAN@KENSITARCHITECTS.COM.AU

NOMINATED ARCHITECT: DEAN KENSIT

NSW REG NO: 9968 ACT REG NO: 2574

21.04.25

06.07.25

05.08.25

19.08.25

This drawing is to be read in conjunction with all other contract documents inclusive of all schedules, specifications and other consultants documentation. Any discrepancies or inconsistencies are to be clarified prior to works. Written dimensions take precedence over scaled dimensions. This drawing is copyright and shall remain the property of Kensit Architects.

DA DRAFT ISSUE

DA ISSUE

DA ISSUE

CONSULTANT ISSUE

AMPOL ROAD PANTRY SERVICE STATION 189 BOURKE ST SINGLE STOREY -**EXISTING COMMERICAL** LOT 5 BUILDING DP778947 187 BOURKE ST ANE STRE FENWICK REAR TWO STOREY -**EXISTING COMMERCIAL** 185 BOURKE ST BUILDING

NOTES

- WRITTEN DIMENSIONS TAKE PRECEDENCE OVER SCALED
- ALL ARCHITECTURAL DOCUMENTATION TO BE READ IN CONJUNCTION WITH ALL CONSULTANT DOCUMENTATION.
 REFER TO MATERIALS AND FINISHES SCHEDULE FOR DETAILS ON
- ALL RELEVANT BUILDING CODES, AUSTRALIAN STANDARDS,
- AUTHORITY REQUIREMENTS AND ACT WORKPLACE SAFETY
- REQUIREMENTS ARE TO BE STRICTLY ADHERED IN CONSTRUCTION. CONNECT STORMWATER LINE TO STORMWATER TIE. EXACT POSITION OF STORMWATER TIE IS TO BE VERIFIED BY BUILDER PRIOR TO
- CONSTRUCTION.

 PROVIDE YARD SUMPS & A.G. LINES AS REQUIRED.
- ALL SETBACKS, FLOOR LEVELS AND CONTOURS ARE TO BE CHECKED ON SITE PRIOR TO CONSTRUCTION.
- NO SPECIFIC FLOOD REQUIREMENTS AS PER FLOOD IMPACT STATEMENT PREPARED BY LMJ CONSULTING ENGINEERS

187 BOURKE STREET GOULBURN

5/-/DP778947 **GOULBURN NSW 2580**

> CONTROLS ZONING: E2 COMMERCIAL CENTRE HEIGHT: FSR: 2:1 (494m²) MIN LOT SIZE:

PROPOSED GFA: 393m² PROPOSED FSR: 1.6:1

ROOF AREA: DCP/LEP SITE COVERAGE: N/A HEIGHT: SETBACKS

FRONT INSTRUMENT 88B 0m SIDE & REAR SOLAR: LIVING 2-3 HRS* POS MIN 3 HRS*

PPOS: PARKING: COMM 1 SPACE PER 40m² SHOPTOP 1 SPACES / UNIT

DEVELOPMENT AREASSITE AREA: 247m² APPROX
5/-/DP778947
GOULBURN NSW 2580 YIELD SCHEDULE:

TYPE QTY 3BR 02 TOTAL UNITS 02

YIELD SCHEDULE: CARPARKING REQUIREMENTS SCHEDULE QTY CARSPACES

COMMERCIAL / OFFICE / SHOP

2 UNITS 02 TOTAL CAR SPACES 06

IT HAS BEEN ASSUMED NOT ALL RESIDENTIAL PARKING WILL BE ONSITE. DISPENSATION MAY BE REQUIRED FOR PARKING OR PARKS FROM OFF

TELL COLUMN TO THE TOWARDS REQUIRED PARKING. MINIMUM ONE PARKING

LEGEND: ON SITE.

> EXISTING ROAD NETWORK INDICATIVE ONSITE DRIVEWAY

BOUNDARY SITE ---- SITE SETBACKS

SERVICES - MAINS SEWER — — — PEDESTRAIN NETWORK / CONNECTION


DEMOLITION / REMOVAL

TREE / VEGETATION

EXISTING BUILT FORM

SHOPTOP HOUSING

DRAWING TITLE EXISTING SITE PLAN

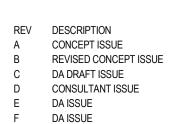

1 EXISTING SITE PLAN

BOURKE

26.05.24 02.12.24 21.04.25 06.07.25 05.08.25 19.08.25

This drawing is to be read in conjunction with all other contract documents inclusive of all schedules, specifications and other consultants documentation. Any discrepancies or inconsistencies are to be clarified prior to works. Written dimensions take precedence over scaled dimensions. This drawing is copyright and shall remain the property of Kensit Architects.


NOMINATED ARCHITECT: DEAN KENSIT NSW REG NO: 9968 ACT REG NO: 2574

ABN 44 379 363 172 WWW.KENSITARCHITECTS.COM.AU DEAN@KENSITARCHITECTS.COM.AU

KENSIT ARCHITECTS

5/-/DP778947 [187 BOURKE ST GOULBURN] 202405 PROJECT No.

SCALE As indicated @ A1 DATE AUGUST 2025

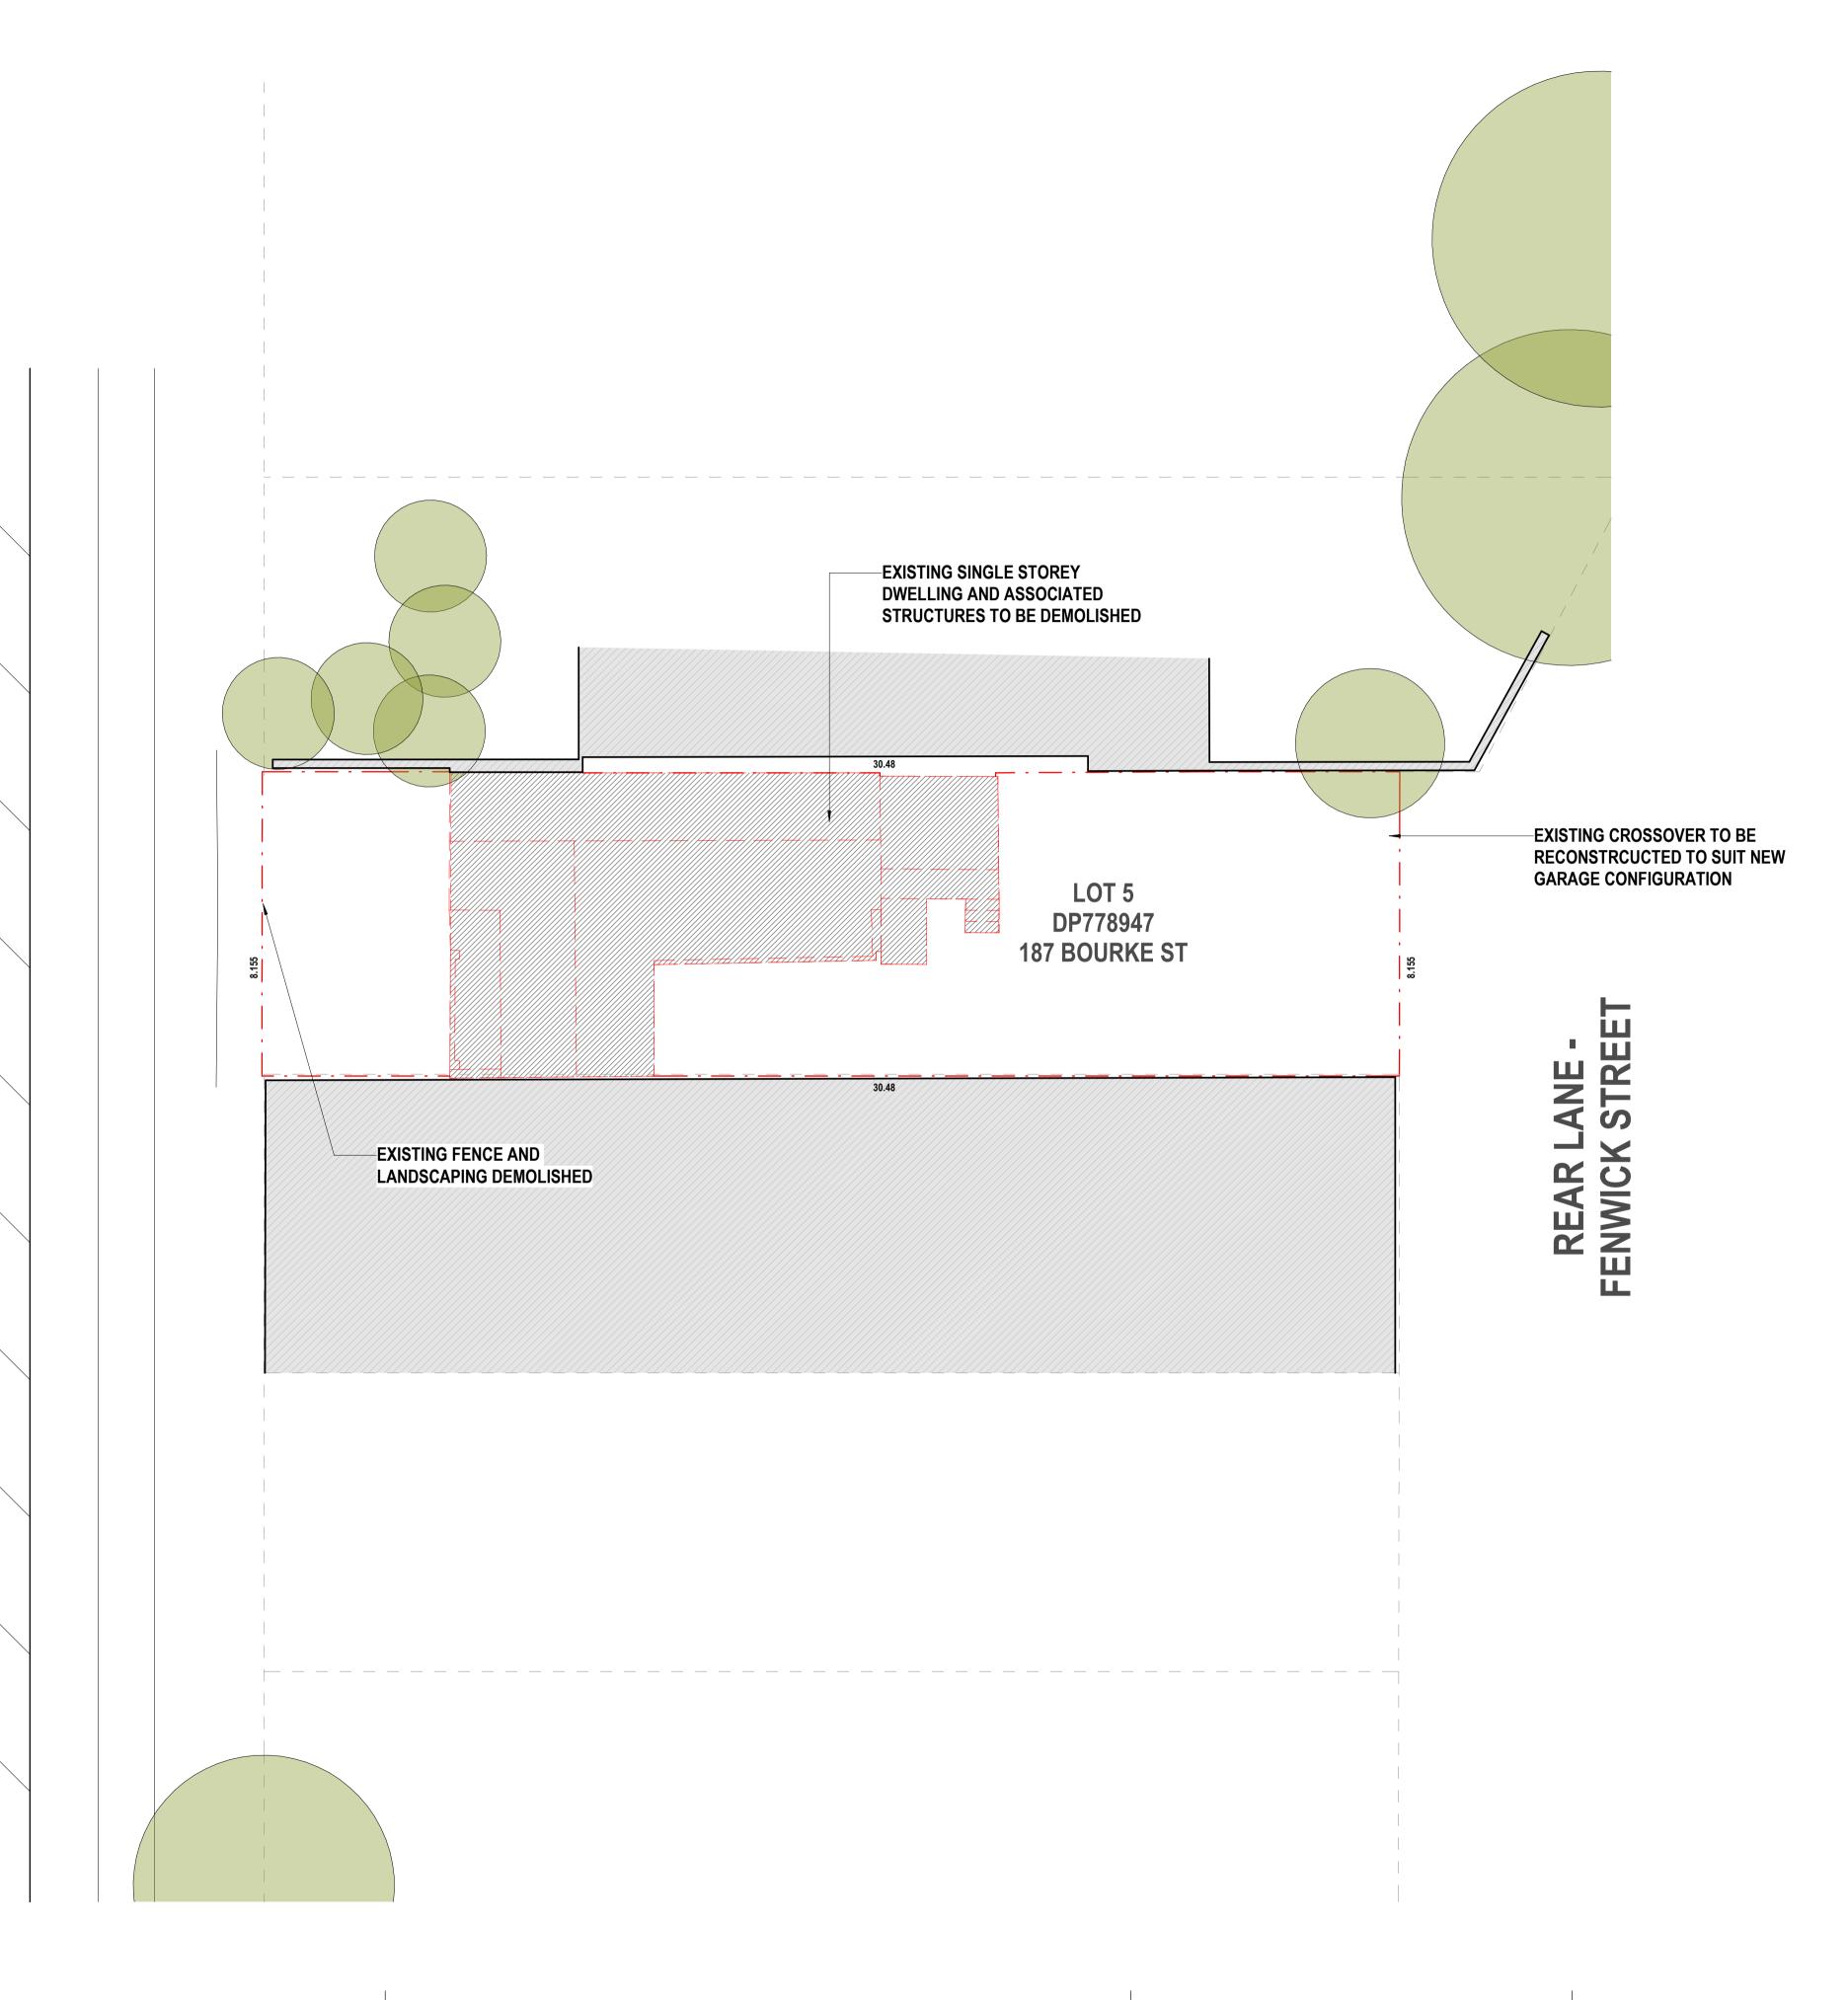

DA 004 DEMOLITION SITE PLAN
1:100 @ A1

REV DESCRIPTION CONCEPT ISSUE REVISED CONCEPT ISSUE DA DRAFT ISSUE CONSULTANT ISSUE DA ISSUE DA ISSUE

26.05.24 02.12.24 21.04.25 06.07.25 05.08.25 19.08.25

This drawing is to be read in conjunction with all other contract documents inclusive of all schedules. rins drawing is to be read in Conjunction with an other contract documents inclusive of an as oriections, specifications and other consultants documentation. Any discrepancies or inconsistencies are to be clarified prior to works. Written dimensions take precedence over scaled dimensions. This drawing is copyright and shall remain the property of Kensit Architects.





PROJECT No.

SHOPTOP HOUSING 5/-/DP778947 [187 BOURKE ST GOULBURN]

202405

DRAWING TITLE **DEMOLITION SITE PLAN**

SCALE As indicated @ A1

DATE AUGUST 2025



DEMOLITION NOTES

BUILDER TO PROVIDE ALL LABOUR, MATERIALS, FITTINGS, PLANT, TOOLS, PERMITS, INSURANCES ETC NECESSARY FOR THE PROPER COMPLETION OF THE WORK AND ENSURE THAT ALL LABOUR AND MATERIALS IN ALL TRADES ARE THE BEST OF THEIR

RESPECTIVE KINDS. BUILDER IS TO INFORM THEMSELF OF ALL SITE CONDITIONS AND SCOPE OF WORK PRIOR TO COMMENCING. ALL NECESSARY ALLOWANCES ARE TO BE INCLUDED SUCH AS COSTS ASSOCIATED WITH DEMOLITION MAKING GOOD, MATCHING EXISTING DETAIL, TRAVELING COSTS AND THE LIKE AS REQUIRED FOR THE SATISFACTORY COMPLETION OF THE ALTERATIONS WHETHER EXPRESSLY INDICATED OR NOT AND AS

NECESSITATED BY SITE CONDITIONS. WHERE ADJUSTMENTS ARE REQUIRED TO SUITE SITE CONDITIONS CONSULT CLIENT FOR APPROVAL. MATERIALS AND WORKMANSHIP TO BE IN ACCORDANCE WITH THE BUILDING CODE OF AUSTRALIA, THE NSW APPENDIX, AND ALL OTHER RELEVANT CODES.

DEMOLITION PROVIDE ALL NECESSARY DEMOLITION WORK REQUIRED FOR THE PROPER COMPLETION OR OF THE RENOVATIONS, ALTERATIONS AND ALL OTHER ASSOCIATED

WHERE DEMOLITION WORK IS CARRIED OUT ENSURE THAT ADEQUATE STRUCTURAL SUPPORT IS PROVIDED TO MAINTAIN THE INTEGRITY OF EXISTING STRUCTURE PRIOR TO REMOVING ANY EXISTING BUILDING ELEMENT.

PROTECT MATERIALS AND PROPERTY FROM DAMAGE. MAKE GOOD EXISTING WORK THAT HAS BEEN DAMAGED. NEW DETAIL TO MATCH EXISTING WHERE APPROPRIATE AND, UNLESS OTHERWISE DIRECTED, NEW FINISH TO BLEND INTO ADJACENT

SERVICES: WHERE EXISTING SERVICES ARE TO BE MODIFIED, DISCONNECTED, OR RELOCATED ENSURE THAT ALL REDUNDANT SERVICES ARE MADE SAFE.

MATERIALS AND COMPONENTS

HAZARDOUS MATERIALS. GIVE NOTICE IMMEDIATELY ANY HAZARDOUS MATERIALS OR CONDITIONS ARE FOUND. DEMOLISHED MATERIALS

EXCEPT FOR MATERIALS AS DIRECTED BY THE CLIENT TO BE SALVAGED OR RE-USED, DEMOLISHED MATERIALS ARE THE PROPERTY OF THE CONTRACTOR AND MUST BE REMOVED FROM THE SITE. DO NOT BURN OR BURY DEMOLISHED MATERIALS ON THE

SALVAGE: RECOVER MATERIALS TO BE SALVAGED OR RE-USED WITHOUT DAMAGE. RE-USE: RE-USE ONLY MATERIALS RECOVERED FROM THE DEMOLITIONS IN A SOUND AND SUITABLE CONDITION.

STORAGE: STORE IN AN APPROVED LOCATION ANY MATERIALS TO BE RE-USED.
REMOVAL: COVER MATERIALS IN TRANSIT TO PREVENT SPILLAGE.

PROVIDE TEMPORARY SUPPORT FOR SECTIONS OF EXISTING BUILDINGS WHICH ARE TO BE ALTERED AND WHICH NORMALLY RELY FOR SUPPORT, ON WORK TO BE DEMOLISHED. SUPPORT UNTIL PERMANENTLY SUPPORTED ON NEW WORK. CLEAR AWAY TEMPORARY SUPPORTS ON COMPLETION.

GROUND SUPPORT: SUPPORT EXCAVATIONS FOR DEMOLITION OF UNDERGROUND STRUCTURES.

WEATHER PROTECTION

IF WALLS OR ROOFS ARE OPENED FOR ALTERATIONS AND ADDITIONS OR THE SURFACES OF ADJOINING BUILDINGS ARE EXPOSED, PROVIDE TEMPORARY COVERS TO PREVENT WATER PENETRATION. PROVIDE COVERS TO PROTECT EXISTING PLANT AND EQUIPMENT AND MATERIALS INTENDED FOR RE-USE.

DUST PROTECTION PROVIDE DUST-PROOF SCREENS, BULKHEADS AND COVERS TO PROTECT EXISTING FINISHES AND THE IMMEDIATE ENVIRONMENT FROM DUST AND DEBRIS.

EXPLOSIVES DO NOT USE EXPLOSIVES. POLLUTION:


AS PER AUSTRALIAN STANDARDS AND ACT POLLUTION CONTROL LAWS ASBESTOS:

SHOULD THERE BE ANY TRACE OF ASBESTOS IN THE EXISTING HOME, IT SHOULD BE DISPOSED OF BY A SUITABLY QUALIFIED AND LICENSED PERSON AS PER AUSTRALIAN STANDARDS **EXISTING SERVICES:**

ELECTRICITY TO BE DISCONNECTED AS PER ACTEWAGL REQUIREMENTS AND RELOCATED THROUGH TEMPOARY SUPPLY. SEWERAGE AND STORMWATER TO BE CAPPED OFF. WATER SUPPLY TO BE TERMINATED AND CONNECTED ON A TEMPORARY SUPPLY BASIS. TELEPHONE TO BE DISCONNECTED AND THE LINE REMOVED BY TELSTRA


VEGETATION: TREES FOR REMOVAL ARE TO BE REMOVED WITHOUT DISTURBANCE TO THOSE TREES TO BE RETAINED AND TAKEN TO THE APPROPRIATE AREA OF THE TIP. CARE MUST BE TAKEN IN RELATION TO OVER-HEAD POWER LINES



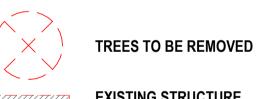

EXISTING STRUCTURE TO BE DEMOLISHED

FOR NOMINATED TREE REMOVAL REFER TO ARBORICULTURAL ASSESSMENT & TREE PROTECTION PLAN WHERE REQUIRED

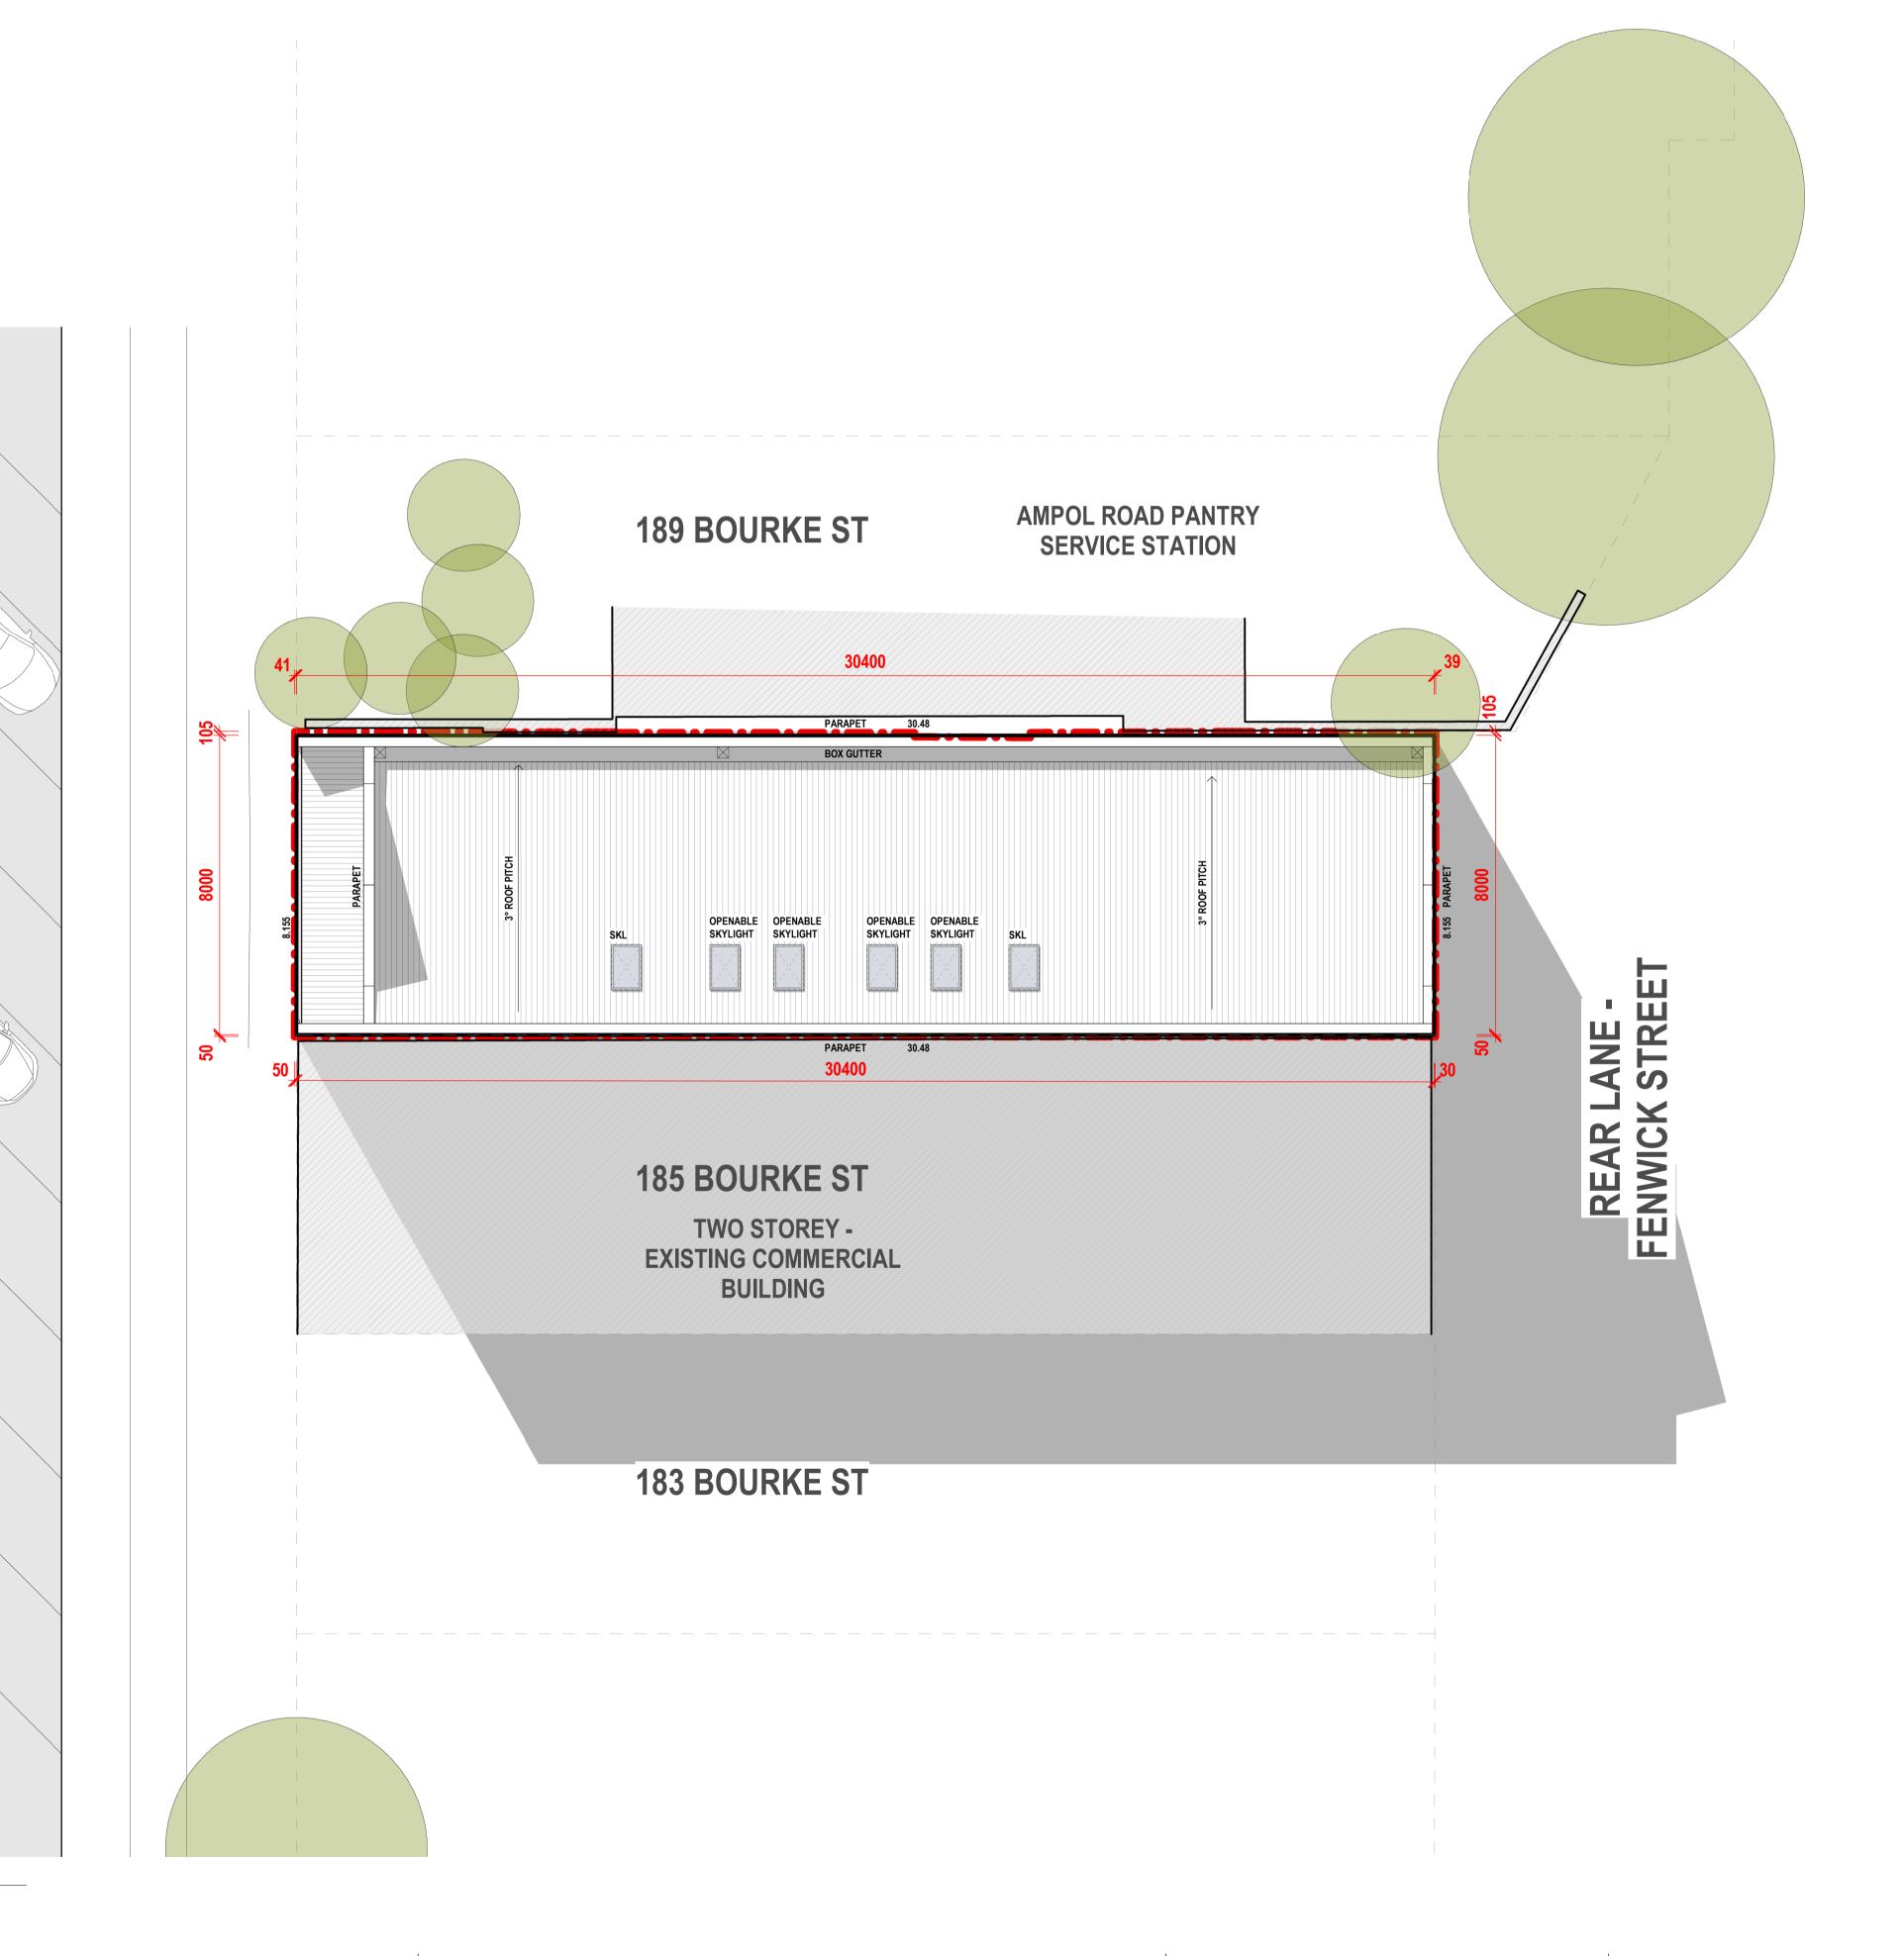

1 PROPOSED SITE PLAN
1: 100 @ A1

BOURKE

REV DESCRIPTION CONCEPT ISSUE REVISED CONCEPT ISSUE DA DRAFT ISSUE CONSULTANT ISSUE DA ISSUE DA ISSUE

26.05.24

02.12.24

21.04.25

06.07.25

05.08.25

19.08.25

This drawing is to be read in conjunction with all other contract documents inclusive of all schedules. specifications and other consultants documentation. Any discrepancies or inconsistencies are to be clarified prior to works. Written dimensions take precedence over scaled dimensions. This drawing is copyright and shall remain the property of Kensit Architects.

KENSIT ARCHITECTS ABN 44 379 363 172 WWW.KENSITARCHITECTS.COM.AU DEAN@KENSITARCHITECTS.COM.AU NOMINATED ARCHITECT: DEAN KENSIT NSW REG NO: 9968 ACT REG NO: 2574

PROJECT No.

SHOPTOP HOUSING 5/-/DP778947 [187 BOURKE ST GOULBURN] 202405

DRAWING TITLE PROPOSED SITE PLAN

SCALE 1:100@A1

DATE AUGUST 2025

DWG **DA 010**

NOTES

WRITTEN DIMENSIONS TAKE PRECEDENCE OVER SCALED

ALL ARCHITECTURAL DOCUMENTATION TO BE READ IN CONJUNCTION WITH ALL CONSULTANT DOCUMENTATION.
 REFER TO MATERIALS AND FINISHES SCHEDULE FOR DETAILS ON

ALL SETBACKS, FLOOR LEVELS AND CONTOURS ARE TO BE CHECKED

• ALL RELEVANT BUILDING CODES, AUSTRALIAN STANDARDS, AUTHORITY REQUIREMENTS AND ACT WORKPLACE SAFETY REQUIREMENTS ARE TO BE STRICTLY ADHERED IN CONSTRUCTION. CONNECT STORMWATER LINE TO STORMWATER TIE. EXACT POSITION OF STORMWATER TIE IS TO BE VERIFIED BY BUILDER PRIOR TO

 NO SPECIFIC FLOOD REQUIREMENTS AS PER FLOOD IMPACT STATEMENT PREPARED BY LMJ CONSULTING ENGINEERS

E2 COMMERCIAL CENTRE

CONSTRUCTION.

PROVIDE YARD SUMPS & A.G. LINES AS REQUIRED.

2:1 (494m²)

LIVING 2-3 HRS*

1 SPACE PER 40m²

QTY CARSPACES

IT HAS BEEN ASSUMED NOT ALL RESIDENTIAL PARKING WILL BE ONSITE. DISPENSATION MAY BE REQUIRED FOR PARKING OR PARKS FROM OFF STREET COUNTED TOWARDS REQUIRED PARKING. MINIMUM ONE PARKING

1 SPACES / UNIT

ON SITE PRIOR TO CONSTRUCTION.

187 BOURKE STREET GOULBURN

GOULBURN NSW 2580

PROPOSED GFA: 393m² PROPOSED FSR: 1.6:1

SITE COVERAGE: N/A

INSTRUMENT 88B 0m SIDE & REAR SOLAR:

DEVELOPMENT AREASSITE AREA: 247m² APPROX
5/-/DP778947
GOULBURN NSW 2580

YIELD SCHEDULE: TYPE QTY

3BR 02 TOTAL UNITS 02

YIELD SCHEDULE:

CARPARKING REQUIREMENTS SCHEDULE

COMMERCIAL / OFFICE / SHOP

SPACE PER UNIT ON SITE.

CONTROLS ZONING:

MIN LOT SIZE:

ROOF AREA:

DCP/LEP

SETBACKS FRONT

POS MIN 3 HRS*

PPOS:


COMM


PARKING:


SHOPTOP

HEIGHT: FSR:



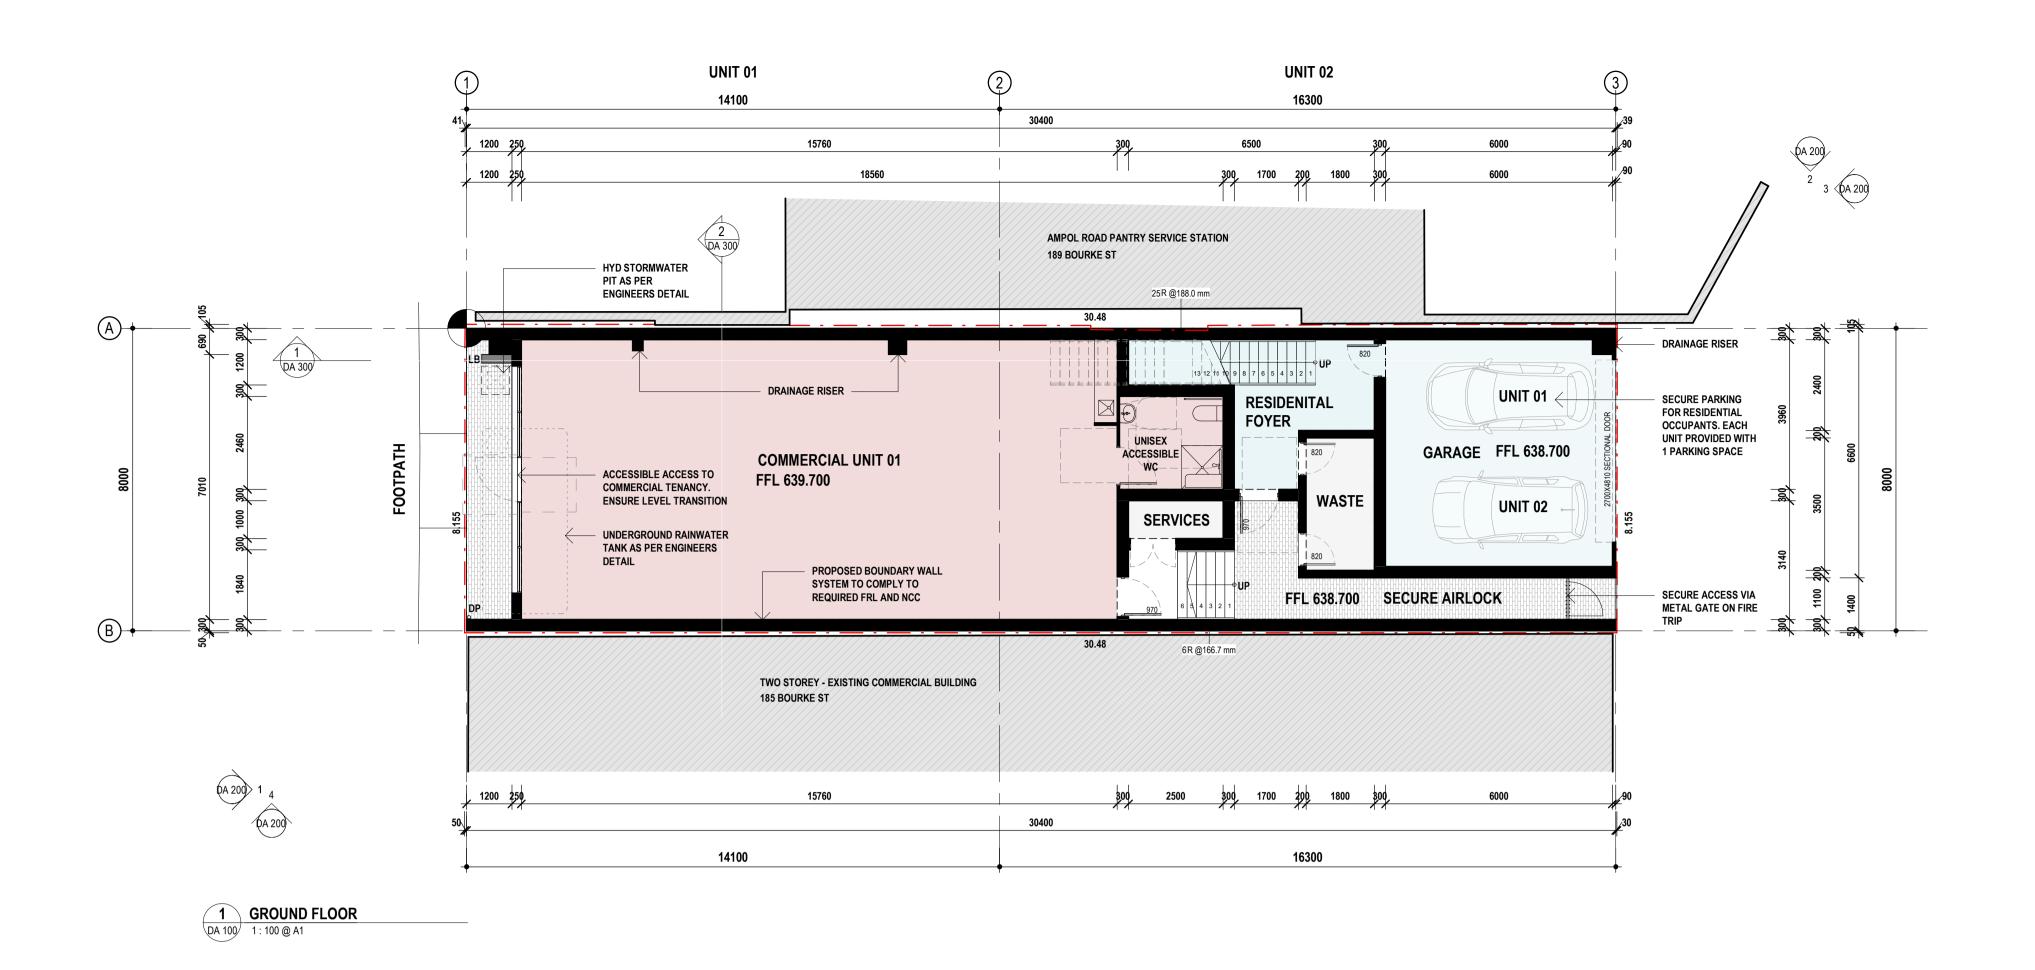

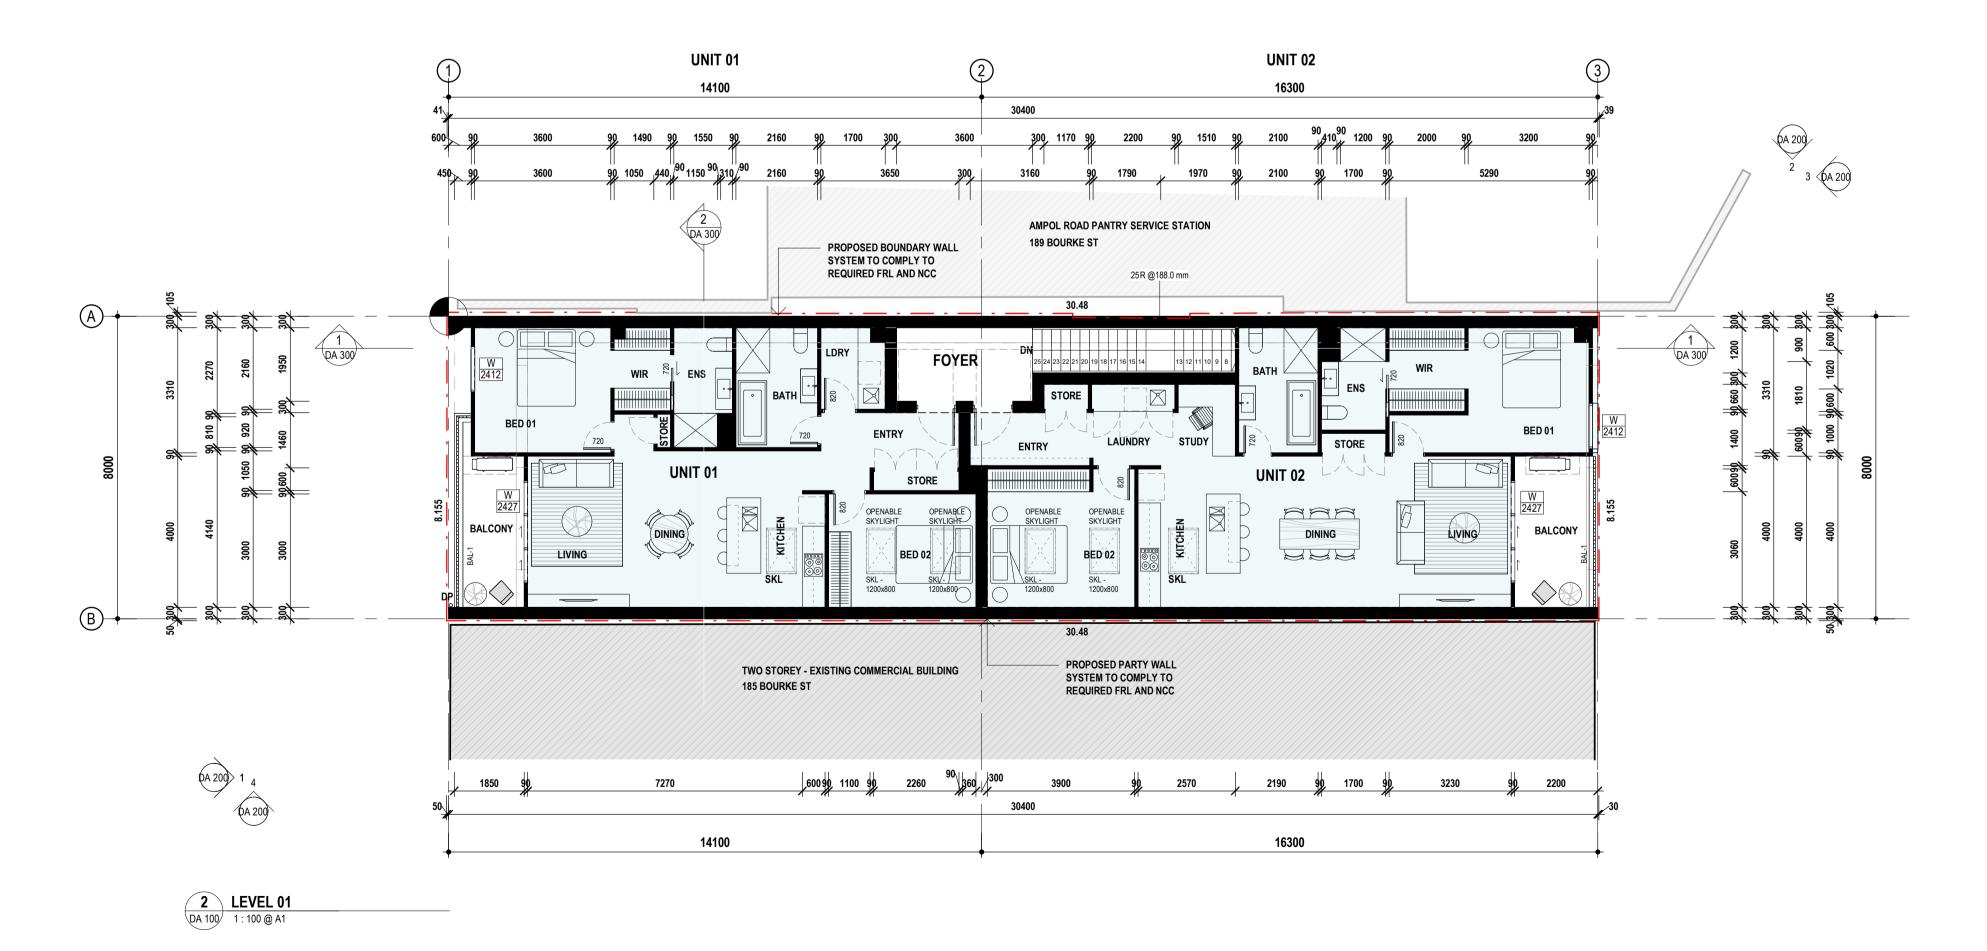

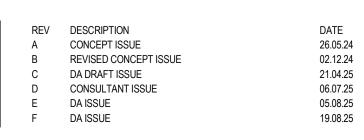





PROJECT SHOPTOP HOUSING

5/-/DP778947 [187 BOURKE ST GOULBURN]

202405

PROJECT No.

DRAW
DULBURN]

DRAWING TITLE FLOOR PLANS

SCALE 1:100@A1

DATE AUGUST 2025

DWG DA 1



WRITTEN DIMENSIONS TAKE PRECEDENCE OVER SCALED

WITH ALL CONSULTANT DOCUMENTATION.

PROVIDE YARD SUMPS & A.G. LINES AS REQUIRED.

ON SITE PRIOR TO CONSTRUCTION.

187 BOURKE STREET GOULBURN

ALL ARCHITECTURAL DOCUMENTATION TO BE READ IN CONJUNCTION

REQUIREMENTS ARE TO BE STRICTLY ADHERED IN CONSTRUCTION.
CONNECT STORMWATER LINE TO STORMWATER TIE. EXACT POSITION

OF STORMWATER TIE IS TO BE VERIFIED BY BUILDER PRIOR TO

ALL SETBACKS, FLOOR LEVELS AND CONTOURS ARE TO BE CHECKED

NO SPECIFIC FLOOD REQUIREMENTS AS PER FLOOD IMPACT

STATEMENT PREPARED BY LMJ CONSULTING ENGINEERS

E2 COMMERCIAL CENTRE

2:1 (494m²)

LIVING 2-3 HRS*

1 SPACE PER 40m²

QTY CARSPACES

IT HAS BEEN ASSUMED NOT ALL RESIDENTIAL PARKING WILL BE ONSITE. DISPENSATION MAY BE REQUIRED FOR PARKING OR PARKS FROM OFF STREET COUNTED TOWARDS REQUIRED PARKING. MINIMUM ONE PARKING

1 SPACES / UNIT

REFER TO MATERIALS AND FINISHES SCHEDULE FOR DETAILS ON

 ALL RELEVANT BUILDING CODES, AUSTRALIAN STANDARDS, AUTHORITY REQUIREMENTS AND ACT WORKPLACE SAFETY

NOTES

DIMENSIONS

MATERIALS.

CONSTRUCTION.

5/-/DP778947

CONTROLS

MIN LOT SIZE:

ROOF AREA:

DCP/LEP

HEIGHT:

FRONT

SOLAR:

PPOS:

COMM SHOPTOP

PARKING:

5/-/DP778947 GOULBURN NSW 2580

TYPE

(125m²)

YIELD SCHEDULE:
TYPE QTY
3BR 02
TOTAL UNITS 02

YIELD SCHEDULE:

CARPARKING REQUIREMENTS SCHEDULE

COMMERCIAL / OFFICE / SHOP

2 UNITS TOTAL CAR SPACES

SPACE PER UNIT ON SITE.

SETBACKS

SIDE & REAR

POS MIN 3 HRS*

ZONING: HEIGHT: FSR:

GOULBURN NSW 2580


PROPOSED GFA: 393m²

PROPOSED FSR: 1.6:1

SITE COVERAGE: N/A

INSTRUMENT 88B 0m

DEVELOPMENT AREASSITE AREA: 247m² APPROX

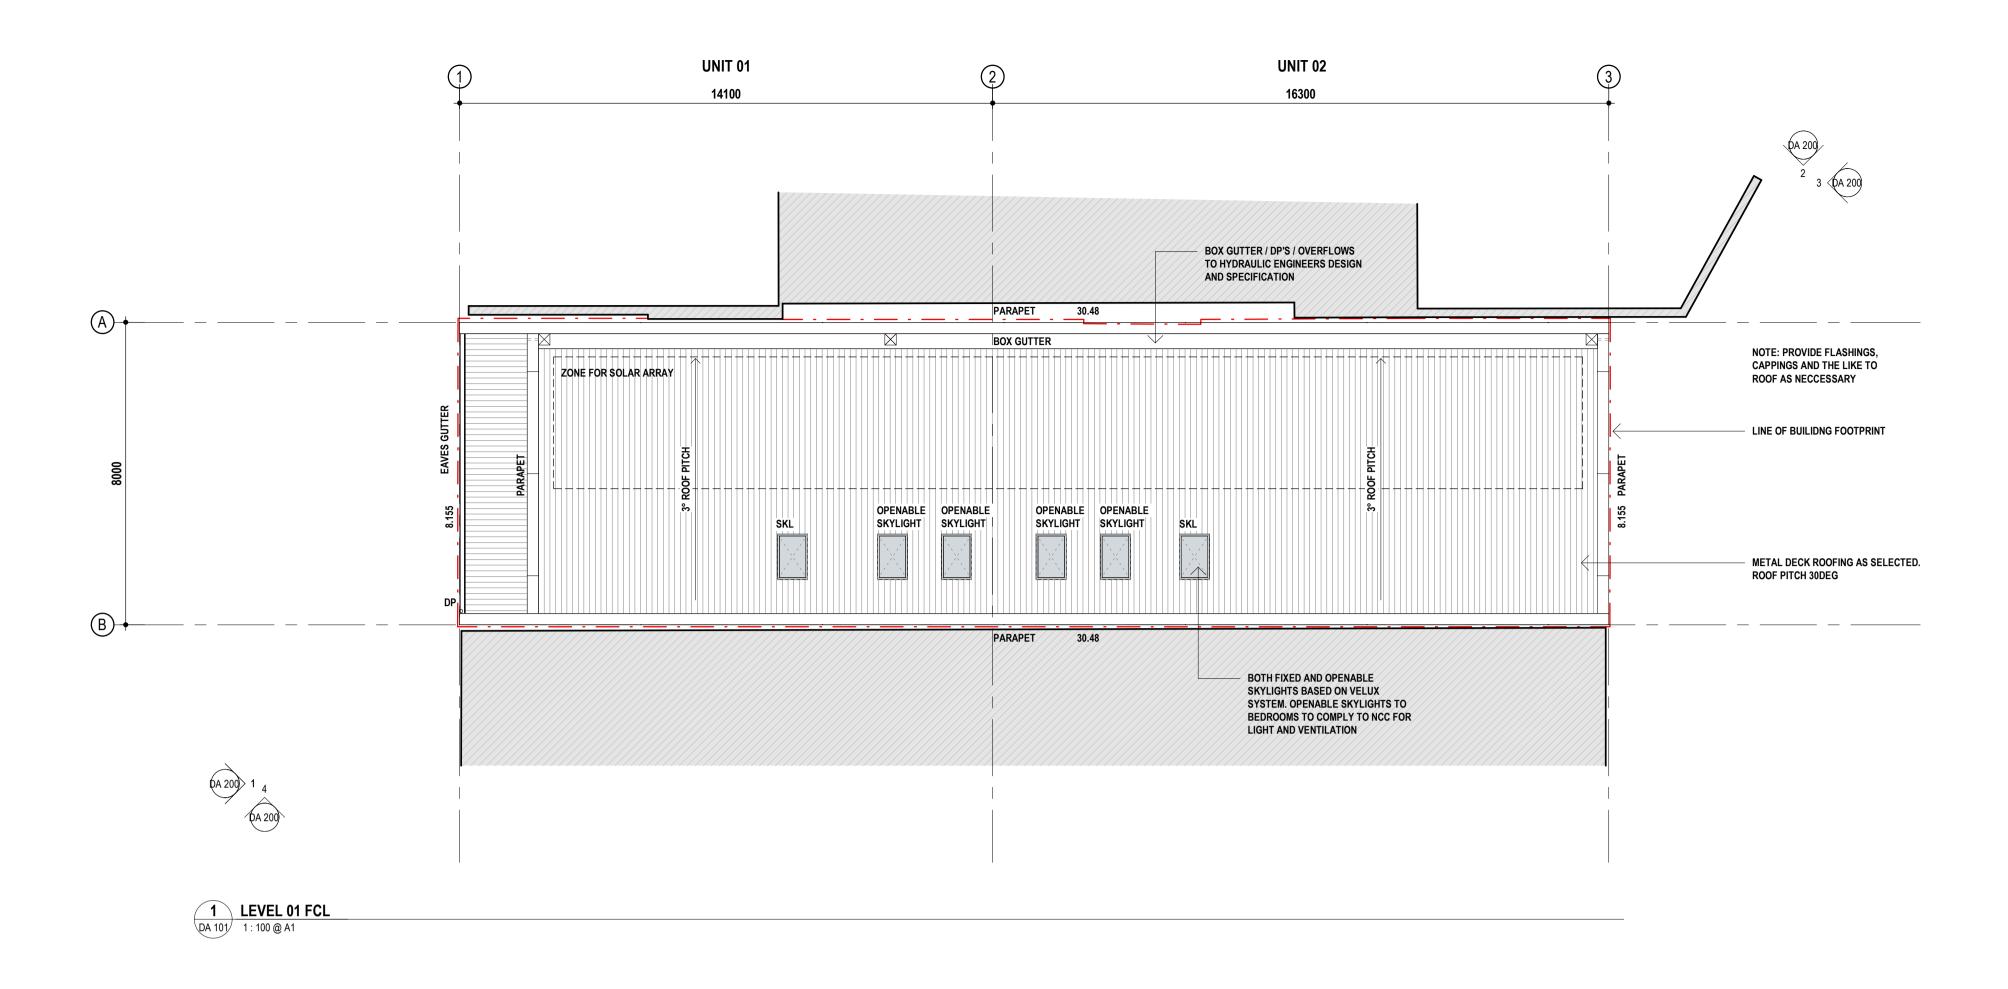

UNCONTROLLED ISSUE

REV DESCRIPTION A CONCEPT ISSUE 26.05.24 REVISED CONCEPT ISSUE 02.12.24 DA DRAFT ISSUE 21.04.25 CONSULTANT ISSUE 06.07.25 DA ISSUE 05.08.25 F DA ISSUE 19.08.25

This drawing is to be read in conjunction with all other contract documents inclusive of all schedules, specifications and other consultants documentation. Any discrepancies or inconsistencies are to be clarified prior to works. Written dimensions take precedence over scaled dimensions. This drawing is copyright and shall remain the property of Kensit Architects.



SHOPTOP HOUSING 5/-/DP778947 [187 BOURKE ST GOULBURN]


PROJECT No.

202405

DRAWING TITLE ROOF PLAN

SCALE 1:100@A1

DATE AUGUST 2025

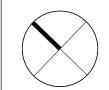

 WRITTEN DIMENSIONS TAKE PRECEDENCE OVER SCALED DIMENSIONS ALL ARCHITECTURAL DOCUMENTATION TO BE READ IN CONJUNCTION WITH ALL CONSULTANT DOCUMENTATION. REFER TO MATERIALS AND FINISHES SCHEDULE FOR DETAILS ON MATERIALS. ALL RELEVANT BUILDING CODES, AUSTRALIAN STANDARDS, AUTHORITY REQUIREMENTS AND ACT WORKPLACE SAFETY REQUIREMENTS ARE TO BE STRICTLY ADHERED IN CONSTRUCTION. CONNECT STORMWATER LINE TO STORMWATER TIE. EXACT POSITION OF STORMWATER TIE IS TO BE VERIFIED BY BUILDER PRIOR TO CONSTRUCTION.

PROVIDE YARD SUMPS & A.G. LINES AS REQUIRED.
 ALL SETBACKS, FLOOR LEVELS AND CONTOURS ARE TO BE CHECKED

 NO SPECIFIC FLOOD REQUIREMENTS AS PER FLOOD IMPACT STATEMENT PREPARED BY LMJ CONSULTING ENGINEERS 187 BOURKE STREET GOULBURN

ON SITE PRIOR TO CONSTRUCTION.

5/-/DP778947 **GOULBURN NSW 2580**

NOTES

CONTROLS ZONING: HEIGHT: E2 COMMERCIAL CENTRE 2:1 (494m²) MIN LOT SIZE:

PROPOSED GFA: 393m² PROPOSED FSR: 1.6:1 ROOF AREA: 192m² DCP/LEP SITE COVERAGE: N/A HEIGHT: 15m SETBACKS FRONT INSTRUMENT 88B 0m SIDE & REAR

SOLAR: LIVING 2-3 HRS* POS MIN 3 HRS* PPOS: PARKING: 1 SPACE PER 40m²

SHOPTOP 1 SPACES / UNIT **DEVELOPMENT AREAS**


SITE AREA: 247m² APPROX

5/-/DP778947 **GOULBURN NSW 2580** YIELD SCHEDULE: TYPE QTY


YIELD SCHEDULE: CARPARKING REQUIREMENTS SCHEDULE

TYPE QTY CARSPACES COMMERCIAL / OFFICE / SHOP (125m²) 2 UNITS TOTAL CAR SPACES

IT HAS BEEN ASSUMED NOT ALL RESIDENTIAL PARKING WILL BE ONSITE. DISPENSATION MAY BE REQUIRED FOR PARKING OR PARKS FROM OFF STREET COUNTED TOWARDS REQUIRED PARKING. MINIMUM ONE PARKING SPACE PER UNIT ON SITE.

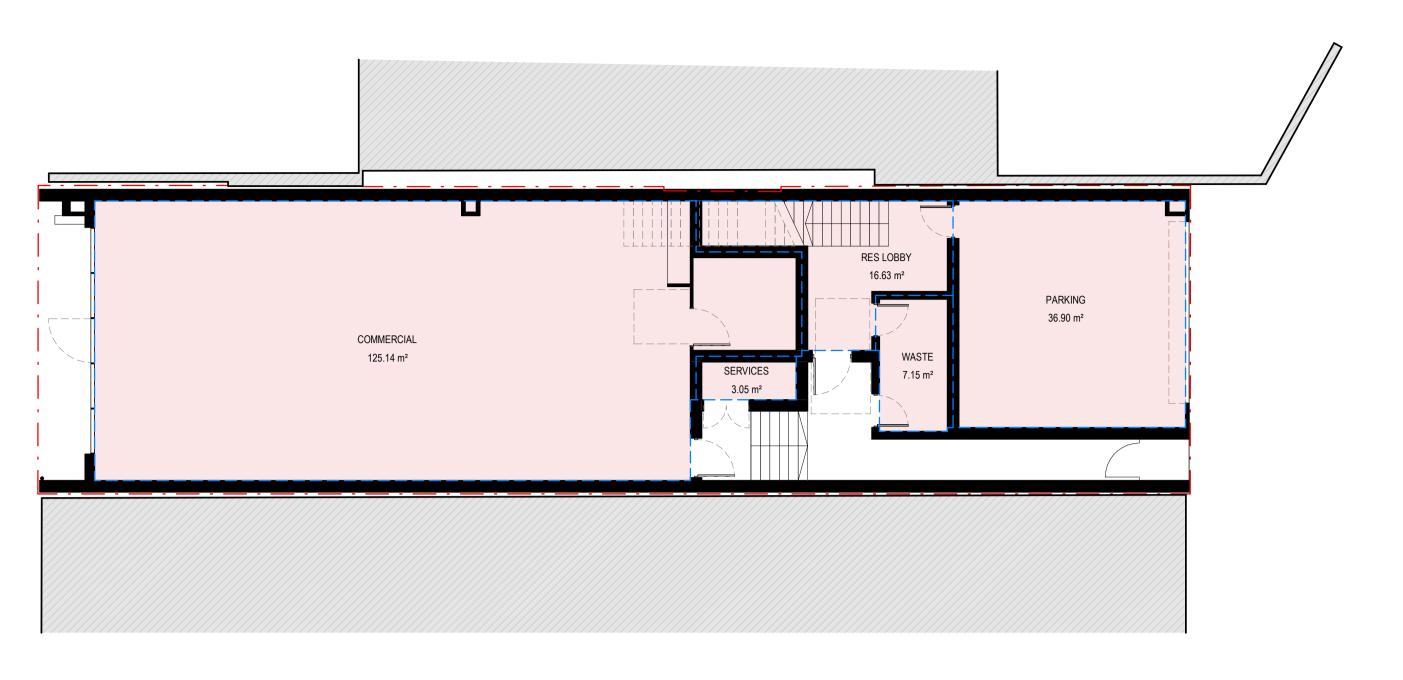

1 GROUND FLOOR
1: 100 @ A1

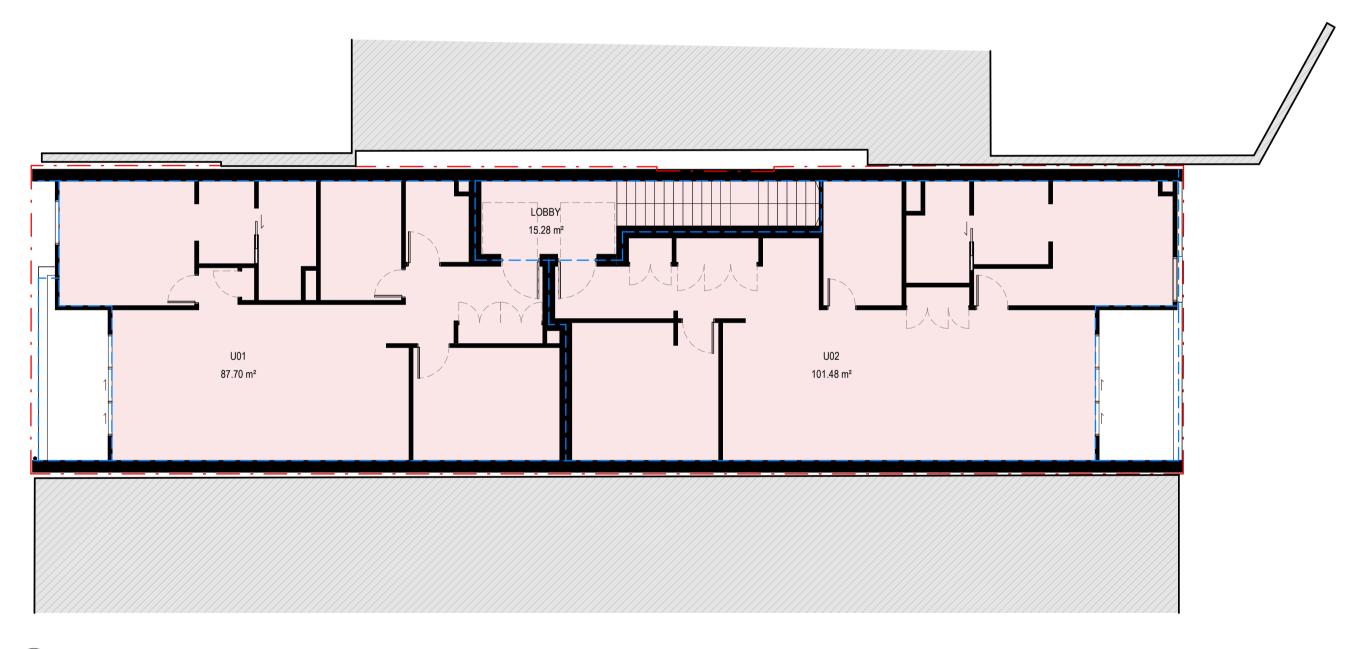

2 LEVEL 01 DA 102 1:100 @ A1

REV DESCRIPTION
A DA DRAFT ISSUE
B CONSULTANT ISSUE
C DA ISSUE
D DA ISSUE

DATE 21.04.25 06.07.25 05.08.25 19.08.25

This drawing is to be read in conjunction with all other contract documents inclusive of all schedules, specifications and other consultants documentation. Any discrepancies or inconsistencies are to be clarified prior to works. Written dimensions take precedence over scaled dimensions. This drawing is copyright and shall remain the property of Kensit Architects.



KENSIT ARCHITECTS ABN 44 379 363 172 WWW.KENSITARCHITECTS.COM.AU DEAN@KENSITARCHITECTS.COM.AU PROJECT SHOPTOP HOUSING

PROJECT No. **202405**

5/-/DP778947 [187 BOURKE ST GOULBURN]

DRAWING TITLE AREA PLANS

SCALE As indicated @ A1

DATE AUGUST 2025

DWG DA 10



FLOOR SPACE RATIO

AREA SCHEDULE (GFA)

GROUND FLOOR COMMERCIAL
GROUND FLOOR PARKING
GROUND FLOOR RES LOBBY
GROUND FLOOR SERVICES
GROUND FLOOR WASTE

187 BOURKE STREET GOULBURN 5/-/DP778947 GOULBURN NSW 2580

CONTROLS


FSR:


2:1 (494m²)


16.6 m²


87.7 m² 101.5 m²

PROPOSED GFA: 393m²
PROPOSED FSR: 1.6:1

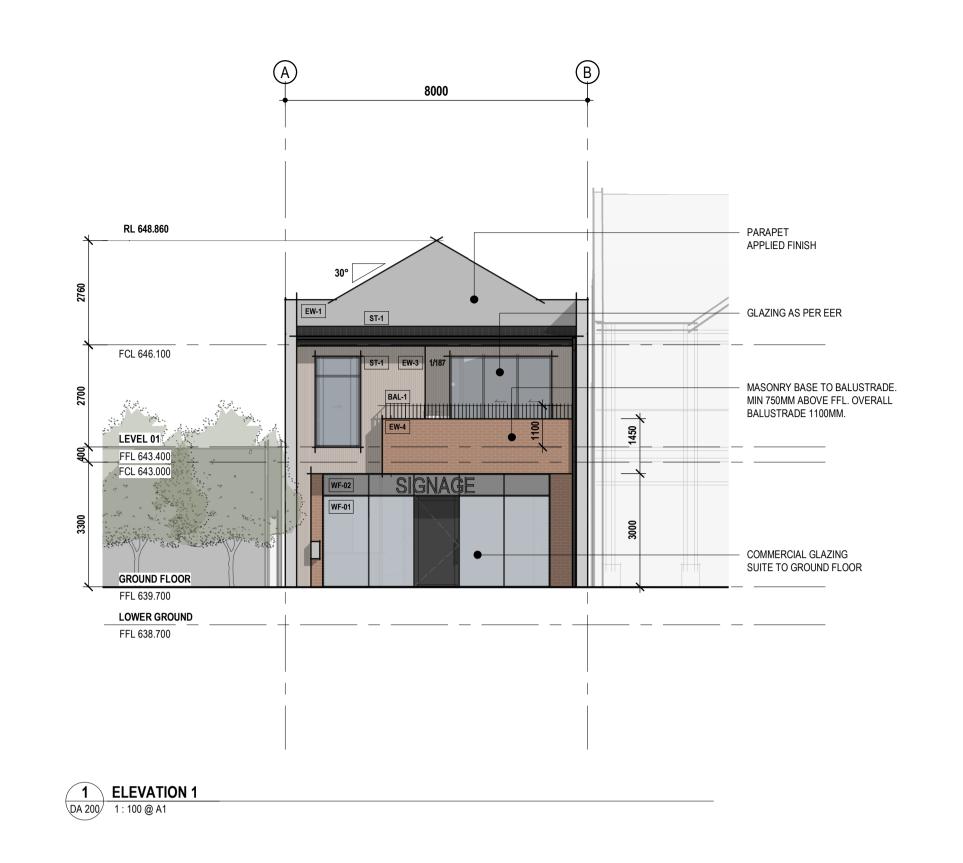

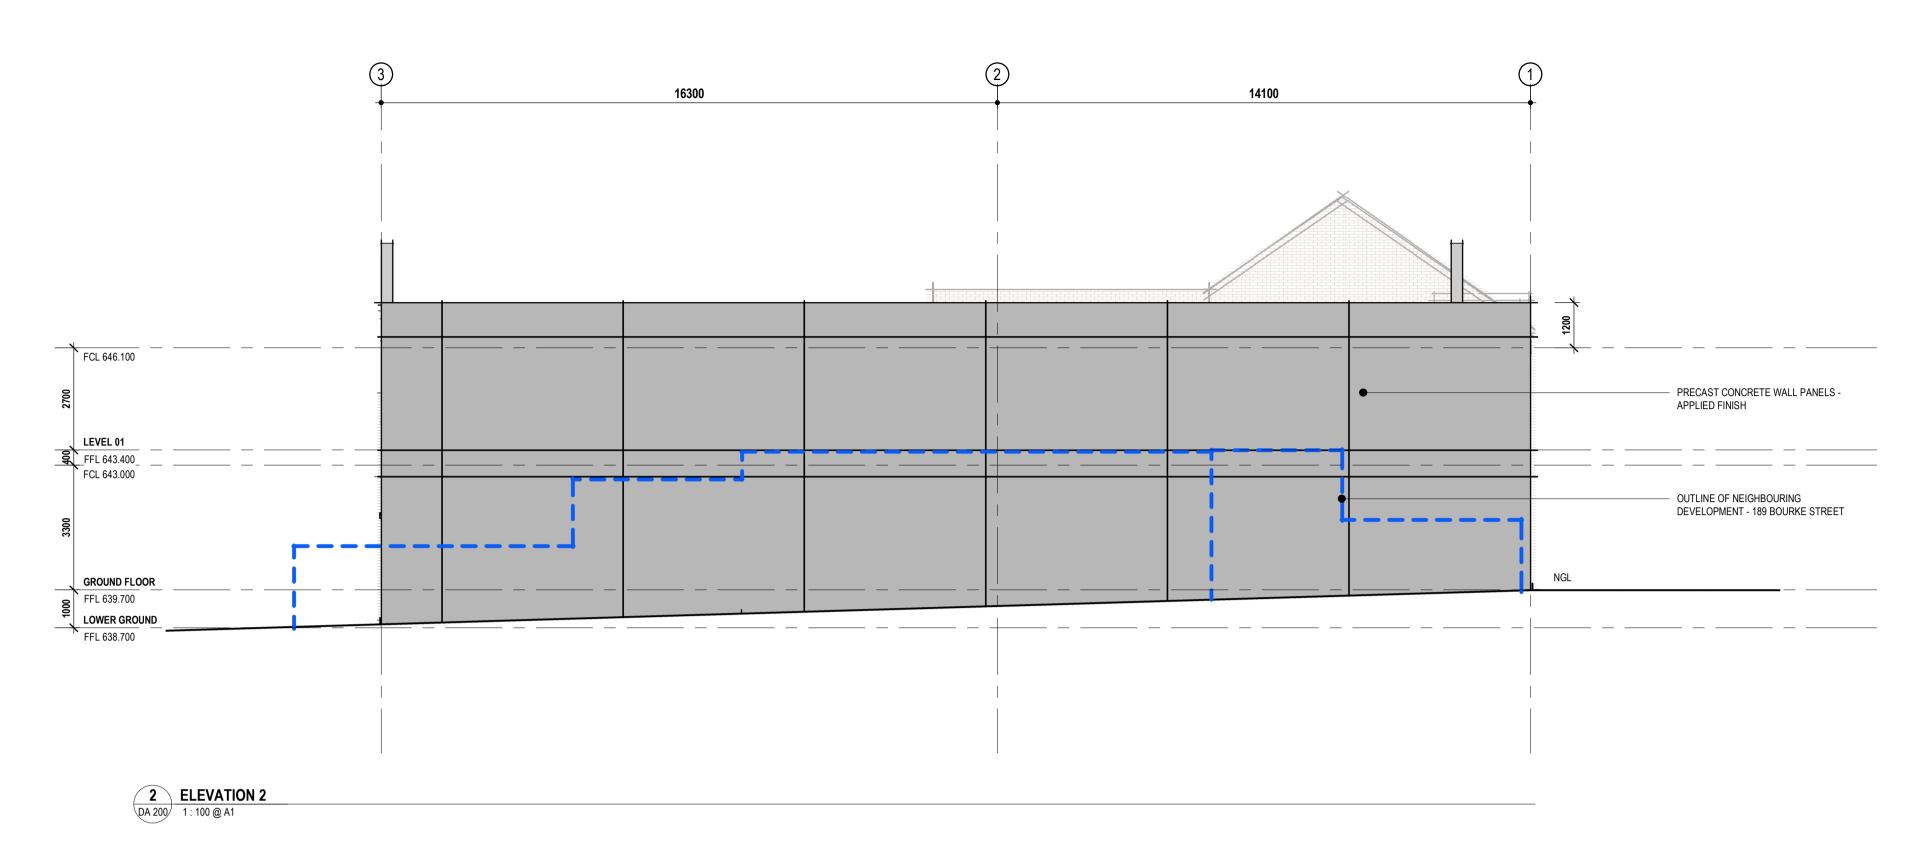

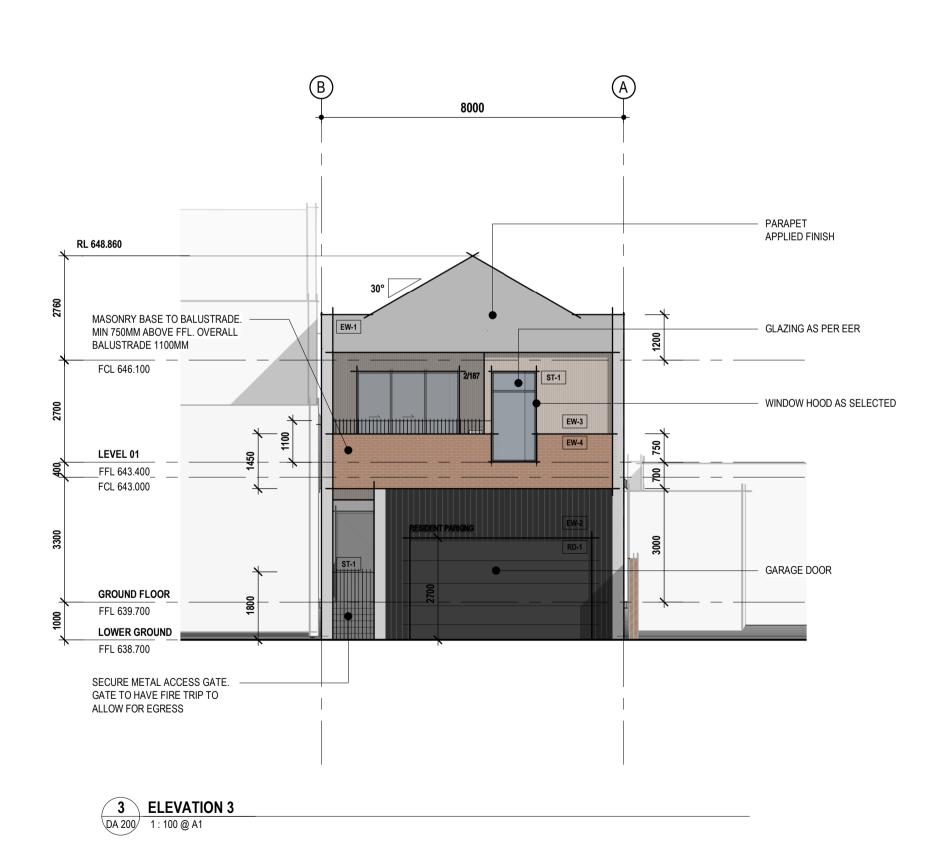

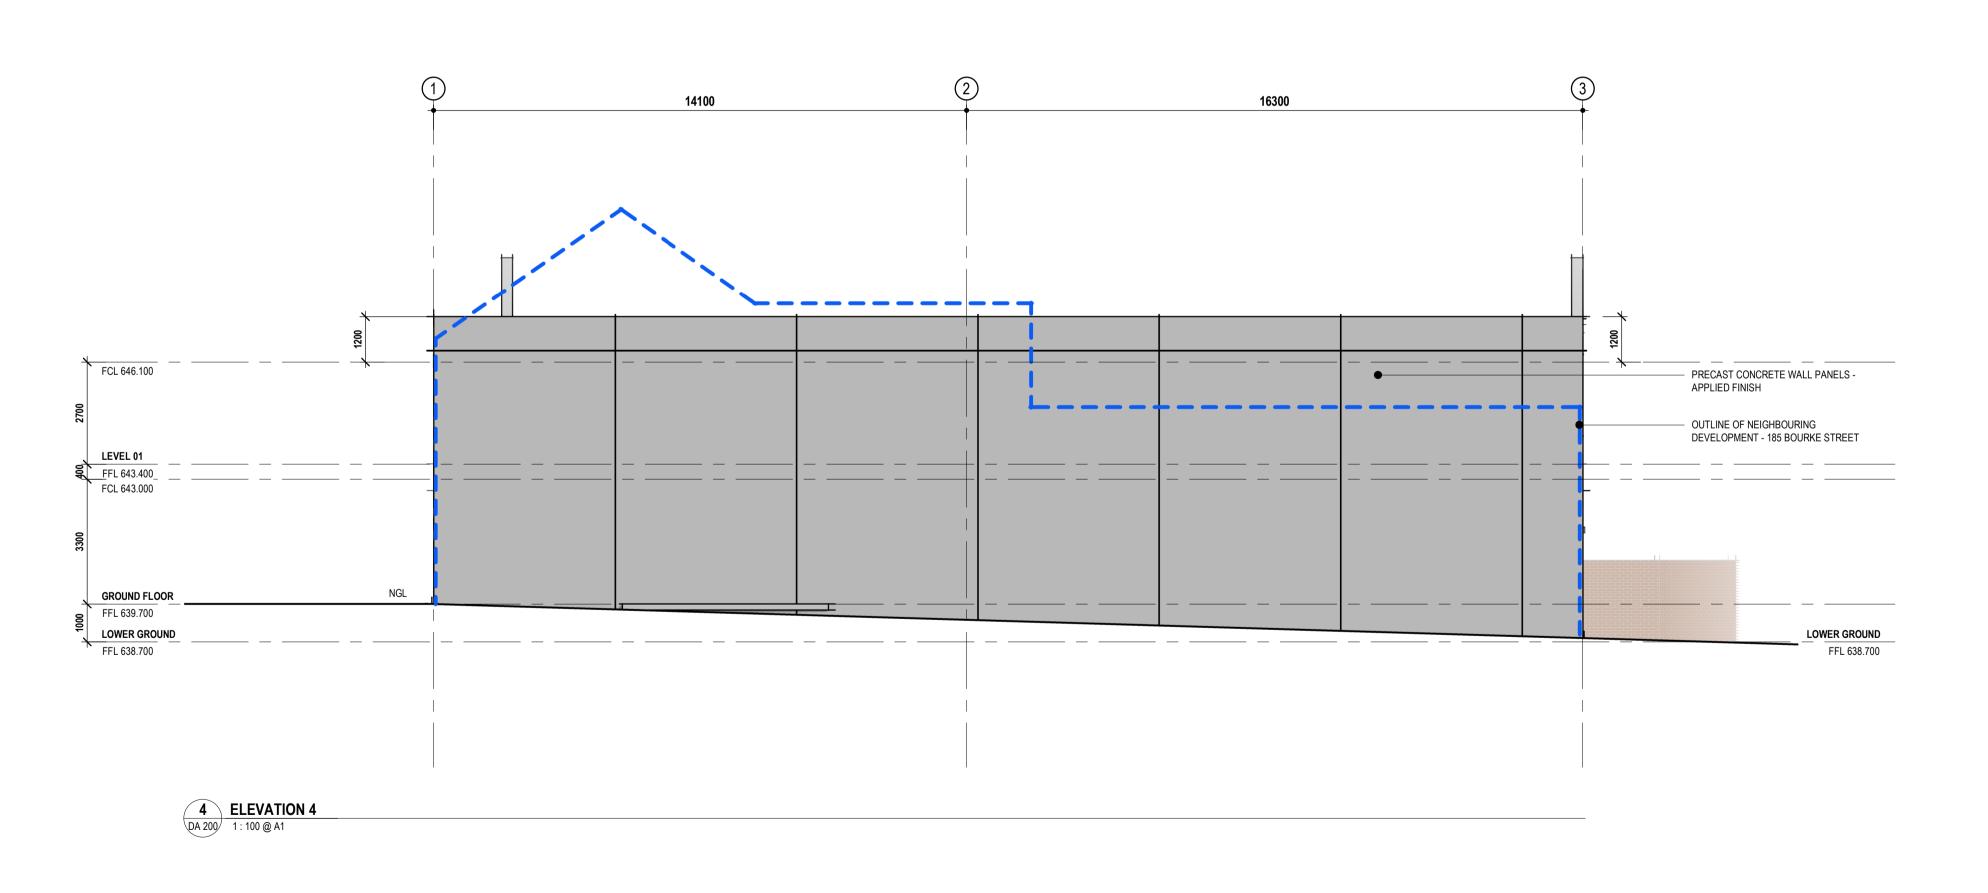

FINISHES SCHEDULE

EXTERIOR WALL: PRECAST CONCRETE RF-1 METAL DECK ROOFING / DPS / GUTTER / FASCIA: COLORBOND - SOUTHERLY RENDER / APPLIED FINISH - GREY

EXTERIOR WALL: VERTICAL

BAL-1 (MINIMUM 1.1m HIGH): STEEL FLAT BAR BALUSTRADE - MONUMENT CLADDING - BLACK CEDAR WF-01 GLAZING CLEAR WITH MONUMENT WINDOW FRAME EXTERIOR WALL: VERTICAL

PREPARED BY DEACON DESIGNS)

CLADDING - SYCAMORE EXTERIOR WALL: BRICKWORK **RECYCLED - NAUTIUS** GARAGE DOOR: METAL - MONUMENT

WF-02 COLOURBACK GLASS WITH MONUMENT WINDOW FRAME ST-1 METAL AWNINGS / STEEL MEMBERS: METAL - MONUMENT (REFER TO EXTERIOR FACADE CONCEPT / MATERIALS / INSPIRATION

NOMINATED ARCHITECT: DEAN KENSIT NSW REG NO: 9968 ACT REG NO: 2574

WWW.KENSITARCHITECTS.COM.AU DEAN@KENSITARCHITECTS.COM.AU PROJECT No.

KENSIT ARCHITECTS

ABN 44 379 363 172

SHOPTOP HOUSING 5/-/DP778947 [187 BOURKE ST GOULBURN] 202405

DRAWING TITLE **ELEVATIONS**

SCALE 1:100@A1

DATE AUGUST 2025

DWG DA 200



1 STREETSCAPE - BOURKE STREET

HERITAGE & URBAN DESIGN CONSIDERATIONS

187 BOURKE STREET, GOULBURN MIXED USE DEVELOPMENT WITHIN GOULBURN HERITAGE CONSERVATION AREA HERITAGE CONTEXT

- The site is located within the Goulburn Heritage Conservation Area.
- The immediate streetscape is mixed in character, with a range of historic and contemporary buildings, including a service station to the north and a two-storey modern mixed-use building to the south.
- The existing structure is non-contributory in heritage terms and its replacement offers an opportunity to enhance the local character through a well-considered

BUILDING FORM & SCALE

- The proposed building adopts a two-storey scale with a central gabled parapet, referencing traditional terrace typologies typical of the historic context.
- The gable pitch is 30°, creating a visual balance of the parapet and aligning with heritage roof forms.
- A projecting verandah element with a lightweight skillion roof creates a clear separation from the main parapet and reflects typical Victorian-era articulation.

MATERIALITY & FAÇADE COMPOSITION

- The building presents a restrained and complementary palette, including:
- Face brickwork at ground level, referencing traditional masonry.
- Rendered precast wall panels to the upper level and parapet to reflect a traditional finish while accommodating modern construction methods while also acknowledging potential future adjoining development.
- The façade articulation is simple yet cohesive, ensuring a strong street address while remaining sympathetic to traditional terrace forms.

VERANDAH & BALCONY EXPRESSION

- The verandah incorporates a lightweight skillion roof in Colorbond (Monument, 5° pitch), consistent with traditional awning forms but expressed in a modern
- The first-floor balcony spans the full width of the façade, incorporating a masonry base for privacy and screening, and vertical steel balustrades above for transparency and rhythm.

FINISHES SCHEDULE

EXTERIOR WALL: PRECAST CONCRETE RF-1 METAL DECK ROOFING / DPS / GUTTER RENDER / APPLIED FINISH - GREY / FASCIA: COLORBOND - SOUTHERLY

EXTERIOR WALL: VERTICAL CLADDING - BLACK CEDAR

copyright and shall remain the property of Kensit Architects.

EXTERIOR WALL: VERTICAL CLADDING - SYCAMORE

BAL-1 (MINIMUM 1.1m HIGH): STEEL FLAT BAR BALUSTRADE - MONUMENT WF-01 GLAZING CLEAR WITH MONUMENT WINDOW FRAME WF-02 COLOURBACK GLASS WITH MONUMENT WINDOW FRAME

ST-1 METAL AWNINGS / STEEL MEMBERS: METAL - MONUMENT

(REFER TO EXTERIOR FACADE CONCEPT / MATERIALS / INSPIRATION

EXTERIOR WALL: BRICKWORK -RECYCLED - NAUTIUS GARAGE DOOR: METAL - MONUMENT

PREPARED BY DEACON DESIGNS) This drawing is to be read in conjunction with all other contract documents inclusive of all schedules, instructions and other consultants documentation. Any discrepancies or inconsistencies are to be clarified prior to works. Written dimensions take precedence over scaled dimensions. This drawing is

STREET INTERFACE

- A clearly defined shopfront zone features:
 - Framed glazing with highlight windows
 - A solid central entry door
 - Materiality and proportion consistent with traditional commercial frontages

SERVICES & FUNCTIONAL CONSIDERATIONS

- Mechanical and service elements are screened behind solid balustrade sections to ensure a clean architectural expression.
- The rear elevation adopts a modest and functional approach, appropriate to its secondary laneway interface.

SUMMARY

This design reflects a contemporary interpretation of traditional Goulburn building forms, balancing heritage sensitivity with functionality. The proposed development enhances the presentation of the site, contributes positively to the conservation area, and integrates sympathetically with the evolving urban

For Further detailed heritage input refer to the heritage statement in support of this application.

202405

PROJECT No.

DA ISSUE







PENWICK STREET VIEW

(a) A1











EW-2
EXTERIOR WALL
VERTICAL CLADDING
BLACK CEDAR

EW-3
EXTERIOR WALL
VERTICAL CLADDING
SYCAMORE





EW-4
EXTERIOR WALL
RECYCLED BRICKWORK
NAUTIUS





RD-1 GARAGE DOOR METAL MONUMENT





RF-1 METAL DECK ROOFING / DPS / GUTTER / FASCIA COLORBOND SOUTHERLY





BAL-1 (MINIMUM 1.1m HIGH) STEEL FLAT BAR BALUSTRADE MONUMENT





WF-01 GLAZING CLEAR WITH MONUMENT WINDOW FRAME






ST-1 METAL AWNINGS / STEEL MEMBERS METAL MONUMENT


WF-02 COLOURBACK GLASS WITH MONUMENT WINDOW FRAME



DATE AUGUST 2025

SCALE NTS

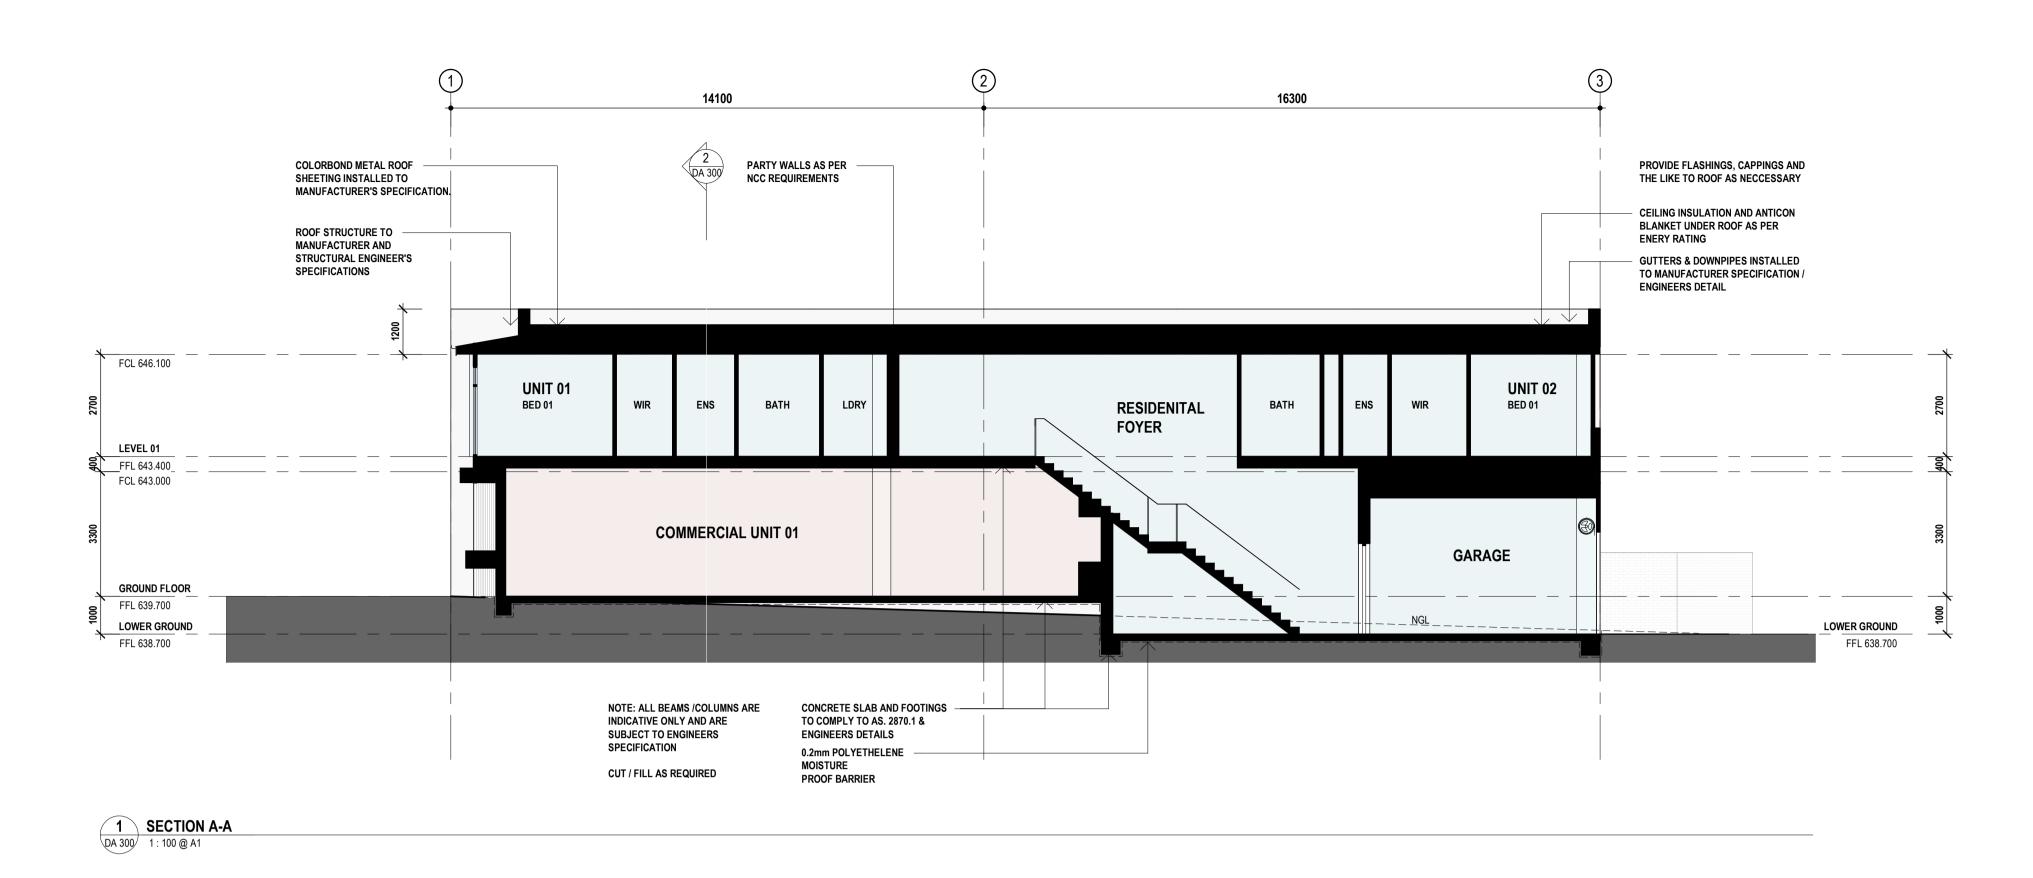

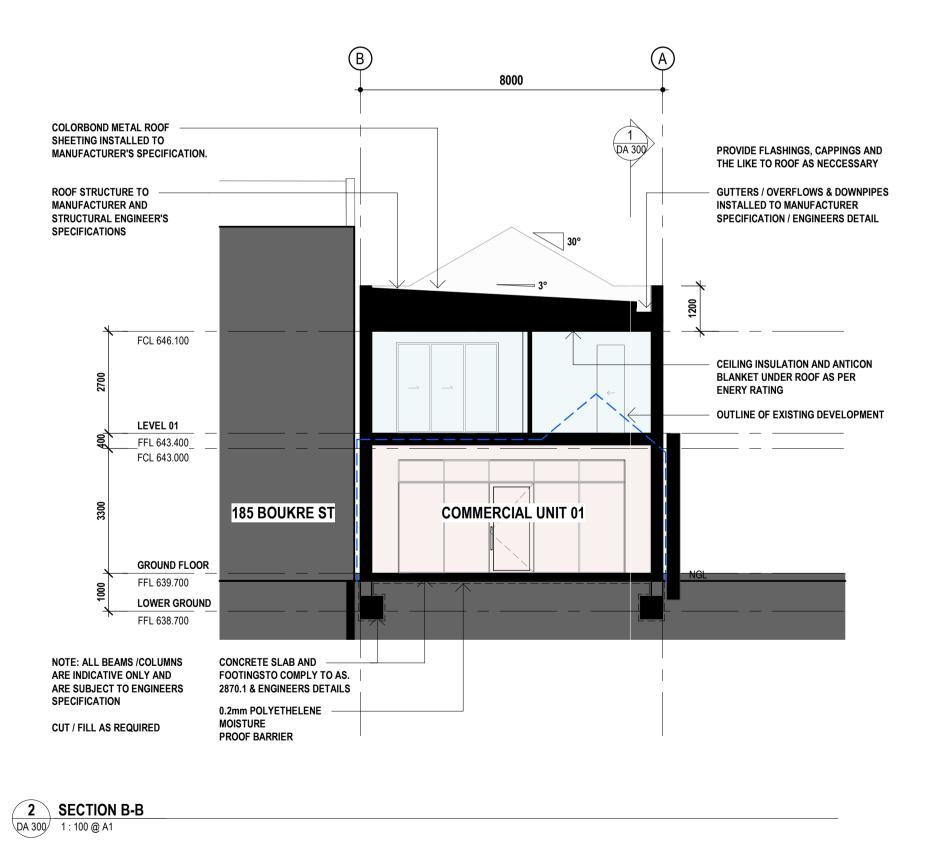

BUILDER TO PROVIDE ALL LABOUR, MATERIALS, FITTINGS, PLANT, TOOLS, PERMITS, INSURANCE AND THE LIKE NECESSARY FOR THE PROPER COMPLETION OF THE WORK AND ENSURE THAT ALL LABOUR AND MATERIALS IN ALL TRADES ARE THE BEST OF THEIR RESPECTIVE KINDS.

BUILDER IS TO VISIT THE SITE AND INFORM HIMSELF OF SCOPE OF WORK PRIOR TO COMMENCING. FOLLOW FIGURED DIMENSIONS ON THE DRAWINGS, CHECK AND VERIFY DIMENSIONS PRIOR TO STARTING ANY WORK.

BUILDING SETBACKS AND DIMENSIONS TO BE VERIFIED BY SURVEYOR PRIOR TO COMMENCING AND WORK. MATERIALS AND WORKMANSHIP TO BE IN ACCORDANCE WITH THE NCC, THE N.S.W. APPENDIX AND ALL OTHER RELEVANT CODES. BUILDER SHALL BE RESPONSIBLE FOR THE GENERAL WATER TIGHTNESS OF THE ENTIRE WORKS IN ALL TRADES.

FOOTINGS

REFER TO ENGINEERING FOR DETAILS FOOTINGS TO BE IN ACCORDANCE WITH ENGINEERING SPECS AND CONCRETE SLAB AS2870 PART 1. FOOTINGS TO BE TAKEN DOWN TO SOLID GROUND.

BRICKWORK AS SELECTED REFER TO DRAWINGS FOR FINISHES UNLESS OTHERWISE NOTED GENERALLY 230X110X76MM BRICKS BONDED IN STRETCHER BOND.

CEMENT MORTAR:

6 PART SAND 1 PART CEMENT 1 PART LIME

LINTELS FOR BRICKWORK REFER TO ENGINEERING FOR DETAILS

WHERE SPANS ARE UP TO 1500MM PROVIDE 150MM BEARING ONTO BRICKWORK. WHERE SPANS ARE OVER 1500MM PROVIDE 230MM BEARING ONTO BRICKWORK. WHERE STEEL ANGLES ARE USED ENSURE THAT THE LONGER LEG

GALVANISED LINTELS SIMILAR TO GALINTELS SPANS UP TO 1000MM: LINTEL 75X10MM - T BEAM 150 SPANS 1200 TO 2100MM: LINTEL 100X100X10MM ANGLE - T BEAM 150 FIBROUS CEMENT SHEET WALL LINING TO WET AREAS. SPANS 2400 TO 3000MM: LINTEL 150X100X10MM ANGLE - T BEAM 250 FOR OTHER SPANS REFER TO MANUFACTURES SPEC OR

TIMBER STUD WORK

ENGINEERS DETAIL.

IS PLACED VERTICAL.

ALL TIMBERWORK TO COMPLY WITH THE REQUIREMENTS OF AS 1684 NATIONAL TIMBER FRAMING CODE TIMBER FLOOR JOIST

TO BE IN ACCORDANCE WITH ENGINEERING PLANS 90X35 PINE PLATES AND NOGGING. PROVIDE SECOND 90X45 TOP PLATE TO ALL LOAD BEARING WALLS. PROVIDE ALL AGRICULTURAL DRAINS AS REQUIRED TO DIVERT WATER AT 600 CTRS TO NON-LOAD BEARING WALLS. PROVIDE 90X45 F8 STUDS TO BOTH SIDES OF OPENINGS CARRYING

F8 TIMBER TO WALLS SUPPORTING TRUSSES WITH SPANS GREATER THAN 6M.

FIBROUS CEMENT SHEET WALL LINING TO EAVES.

50X38MM OR 28mm FURRING CHANNELS CEILING BATTENS AS SELECTED AT 450 CTRS 10MM PLASTERBOARD WALL AND CEILING LINING.

METAL ROOFING - AS NOTED ON DRAWING METAL FASCIA AND GUTTER AS SELECTED. ROOF PITCH (REFER TO DRAWINGS).

TRUSSES AT 600MM CTRS. FIXED TO MANUFACTURES SPECIFICATIONS AND/ OR TO ENGINEERS DETAILS LINTEL SIZE TO TRUSS MANUFACTURERS CHARTS.

PROVIDE DAMP PROOF COURSE AT BEARER SEATING LEVEL

PROVIDE STEPPED CAVITY FLASHING WITH WEEP HOLES AT 1200MM CENTRES TO THE EXTERNAL BRICK SKIN AT GROUND FLOOR LEVEL, UNDER WINDOW SILLS AND IN BRICKWORK ABOVE WINDOWS.

UNLESS OTHERWISE DIRECTED EXTERNAL STEPS TO BE 75MM REINFORCED CONCRETE. RISER: 172MM GOING: 265MM MIN. UNLESS OTHERWISE NOTED.

REFER TO ENGINEERING FOR DETAILS

PROVIDE CLEAN WELL CONSOLIDATED FILL UNDER SLAB AS WHERE FILL EXCEEDS 400MM PROVIDE PIERS TO ENGINEERS

SPECIFICATION MORTAR TO COMPLY WITH THE REQUIREMENTS OF RELEVANT SAA 0.2MM POLYETHYLENE MOISTURE BARRIER UNDER CONCRETE SLAB.

PROVIDE REINFORCED CONCRETE STRIP FOOTING OR THICKENING IN

SLAB UNDER LOAD BEARING WALLS AS PER AS 2870.1 SUSPENDED CONCRETE SLAB IN ACCORDANCE TO ENGINEERS

PLASTERER/INTERNAL LININGS

WALL FRAMING TO ALL ROOMS TO BE COVERED WITH CLOSE JOINT LININGS: THE JOINTS BEING BACKED WITH EITHER NOGGINGS OR STUDS AS REQUIRED BY MANUFACTURER. ALL LININGS SHALL BE SECURELY FIXED. UNLESS OTHERWISE NOTED.

PLASTERBOARD (MIN 10MM THICK) WALL AND CEILING LINING.

PROVIDE SQUARE SET PLASTERING AT INTERSECTIONS OF ALL BEAM AND WALL JUNCTIONS WITH CEILINGS.

DRAINAGE AND PLUMBING PROVIDE ALL NECESSARY DRAINAGE REQUIRED FOR THE DISCHARGE

AND CONNECTION TO APPROPRIATE TIES OF SEWERAGE, STORMWATER AND OTHER DRAINAGE SERVICES AS REQUIRED FOR THE PROPER FUNCTIONING OF THE FACILITIES AS REQUIRED BY THE APPROPRIATE AUTHORITIES.

90X35 PINE STUDS AT 450 CTRS TO ALL LOAD BEARING WALLS AND

AND MOISTURE WHICH MAY CAUSE SEEPAGE TO THE BUILDING STRUCTURE.

PROVIDE ALL NECESSARY PLUMBING MATERIALS AND SERVICES REQUIRED FOR THE PROPER OPERATION OF ALL SANITARY FIXTURES AND FITTINGS, WATER SUPPLY AND RETICULATION, ROOF PLUMBING, FLASHINGS AND THE LIKE AS NECESSITATED BY THE WORKS.

PROVIDE ALL PAINTERS WORK AS REQUIRED BY THE BUILDER AND AS NECESSITATED BY THE NATURE OF THE JOB. WORK TO BE FINISHED IN THE BEST MANNER, ENSURE SURFACES ARE SMOOTH AND PERFECTLY CONDITIONED TO TAKE THE APPLIED FINISH.

PROVIDE ALL NECESSARY MATERIALS, FIXINGS, FRAMES, GLAZING, FLY SCREENS AND THE LIKE CONFORMING TO ALL RELEVANT TRADE PRACTICES AND CODES. ENSURE THE CORRECT OPERATION OF WINDOWS, SLIDING DOORS AND THE LIKE, ENSURING CORRECT PROTECTION FROM WATER AND THE LIKE.

ELECTRICAL

SUPPLY ERECT AND CONNECT ALL NECESSARY MATERIAL TO COMPLETE THE ELECTRICAL INSTALLATION FOR ITS FULL SATISFACTORY OPERATION AND IN ACCORDANCE WITH AUTHORITIES REQUIREMENTS. RELEVANT CODES AND REGULATIONS AND AS DIRECTED BY THE BUILDER.

FORWARD ALL NOTICES, ARRANGE FOR ALL INSPECTIONS AS REQUIRED BY THE RELEVANT AUTHORITIES.

SMOKE ALARMS ARE TO BE INSTALLED IN ACCORDANCE WITH NCC, COMPLY WITH AS3786 AND ALL OTHER RELEVANT CODES. SMOKE ALARMS ARE TO TO MANPOWER WITH BATTERY BACK UP, AND WIRED IN

ACCORDANCE WITH AS3000. SMOKE ALARMS TO BE INTERCONNECTED ON ALL FLOORS

GROUND LEVELS, AND STEPS ARE APPROXIMATE ONLY. ACTUAL GROUND/ SITE CONDITIONS TO BE VERIFIED PRIOR TO CONSTRUCTION.

EXPRESSED JOINTED FIBROUS CEMENT SHEET LINING TO EAVES & CEILINGS WHERE APPICABLE.

LANDING ON BRICK WALLS TO BE 100MM THICK REINFORCED WITH 1 LAYER F718 MESH.

PROVIDE YARD SUMPS AS REQUIRED.

SUB-FLOOR VENTILATION

LOCATION AND SUB-FLOOR CONDITIONS.

THE AREA FOR VENTILATION OF WALL IS BASED ON THE ACCEPTABLE CONSTRUCTION PRACTICE IN TABLE 6.2.1B OF BCA VOLUME 2 AND THE RECOMMENDATIONS OF AS 3660.1-2000 (TERMITES MANAGEMENT - NEW BUILDINGS). WHERE THE SUB-FLOOR IS ENCLOSED BY SOLID MASONRY, PERMANENT VENTS MUST BE INSTALLED IN THE MASONRY DURING CONSTRUCTION. THE BCA, PART 6.2 OUTLINES SUB-FLOOR VENTILATION REQUIREMENTS TO LIMIT THE MOISTURE CONTENT OF FRAMING TIMBERS IN THE SUB-FLOOR SPACE. THE MINIMUM LEVEL OF VENTILATION REQUIRED TO ACHIEVE THIS IS DEPENDENT ON THE

THE STAIRS AND BALUSTRADES, HANDRAILS BEING DESIGNED TO COMPLY WITH PART 11.2 AND PART 11.3 OF THE BCA

PROTECTION OF OPENABLE WINDOWS BEING IN ACCORDANCE WITH PART 11.3.7 & 11.3.8 OF THE BUILDING CODE OF AUSTRALIA HOUSING

NON-SLIP-RESISTANT WALKING SURFACES ON STAIRWAY TREADS AND LANDING(S) NEAR THE EDGE OF THE NOSINGS. OR A NOSING STRIP WITH A SLIP-RESISTANCE CLASSIFICATION NOT LESS THAN THAT LISTED IN TABLE 11.2.4

FLOOR DETAILS Suspended Slab between levels:

WALL DETAILS

Vertical Cladding walls: R2.0 insulation plus 1 breathable wrap R1.5 insulation required Concrete walls: Internal Party Walls between Dwellings: R2.0 insulation on each side

ROOF & CEILING DETAILS R4.0 insulation plus 1 single sided foil Metal Roof:

WINDOWS, GLAZING FRAMES:

GLAZING:

Energy Efficiency Requirements

Aluminium Frames All Windows to be Double Glazed with U-Value=4.10, SHGC=0.52

No insulation required

All Fixed Skylight Windows to be Double Glazed with U-Value=2.58, SHGC=0.24

All Operable Skylight Windows to be Double Glazed with U-Value=2.53, SHGC=0.21 U Value to be equal or less & SHGC can be within 5%

AIR LEAKAGE LIGHTING Exhaust fans to be sealed.

• Windows and sliding doors are fitted with weather seals. External doors to be weather stripped.

•On a verandah or balcony attached to the class 1 4W/sgm

•In a class 10 building (Garage, Shed...) 3W/sqm

• Gaps & Cracks around doors, windows and service penetrations are sealed. All other: as per energy report and plans.

LIGHTING The lamp illumination power density or artificial lighting not to exceed: •In Class 1 building (within the building), 5W/sqm

BCA NOTES ALL WORK TO BE CARRIED OUT IN ACCORDANCE WITH THE NATIONAL CONSTRUCTION CODE AND ALL OTHER APPLICABLE RELEVANT CODES AND STANDARDS INCLUDING BUT NOT LIMITED TO THE FOLLOWING:

-SURFACE WATER DRAINAGE WILL COMPLY WITH 3.3.3 OF THE NATIONAL CONSTRUCTION CODE.

GUTTERS AND DOWNPIPES ARE TO BE NON COMBUSTIBLE AND BE IN ACCORDANCE WITH PART 7.4 OF THE NATIONAL CONSTRUCTION CODE AND ANY BAL / FRL REQUIREMENTS.

-TERMITE BARRIER WILL BE IN ACCORDANCE WITH THE NATIONAL CONSTRUCTION CODE.

-WATERPROOFING WILL BE COMPLIANT WITH AS3740.

-CONDENSATION MANAGEMENT WILL BE COMPLIANT WITH PART

10.8 OF THE NATIONAL CONSTRUCTION CODE. -STAIRS ARE TO BE COMPLIANT WITH PART 3.9.1 OF THE

NATIONAL CONSTRUCTION CODE. -PLUMBING FIXTURES AS PER BASIX CERTIFICATE

BASIX™Certificate

Building Sustainability Index

www.planningportal.nsw.gov.au/development-and-assessment/basix

Multi Dwelling Certificate number: 1807599M

This certificate confirms that the proposed development will meet the NSW government's requirements for sustainability, if it is built in accordance with the commitments set out below. Terms used in this certificate, or in the commitments. have the meaning given by the document entitled "BASIX Definitions" dated 10/09/2020 published by the Department. This document is available at www.planningportal.nsw.gov.au/definitions


Date of issue: Thursday, 07 August 2025
To be valid, this certificate must be submitted with a development application or lodged with a complying development certificate application within 3 months of the date of issue.




When submitting this BASIX certificate with a development application or complying development certificate application, it must be accompanied by NatHERS certificate W55HFSSCZM.

Project summary	·	
roject name	187 Bourke Street, Goulburn NS	SW 2580
treet address	187 BOURKE STREET GOULE	BURN 2580
ocal Government Area	GOULBURN MULWAREE	
lan type and plan number	Deposited Plan 778947	
ot No.	5	
section no.	7 3	
lo. of residential flat buildings	0	
Residential flat buildings: no. of wellings	0	
fulti-dwelling housing: no. of dwellings	2	
lo. of single dwelling houses	0	
Project score		
Vater	✓ 43	Target 40
hermal Performance	✓ Pass	Target Pass
nergy	✓ 65	Target 63
Materials	✓ 21	Target n/a


Certificate Prepared by	
Name / Company Name: Energy Rating Group	
ABN (if applicable):	

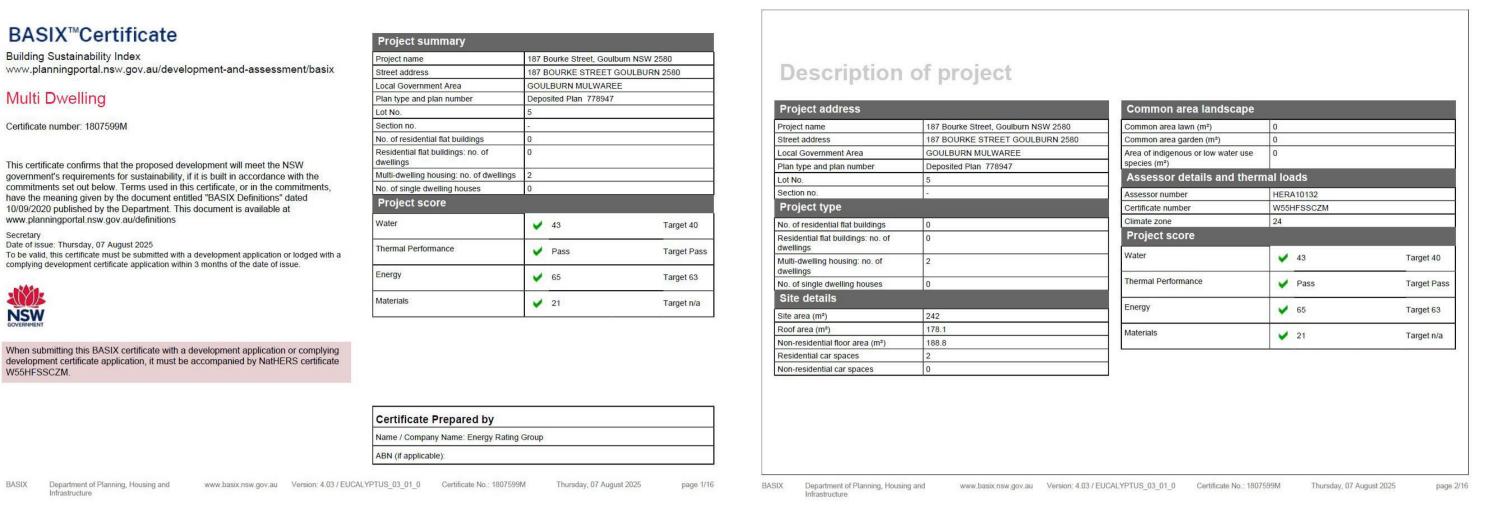


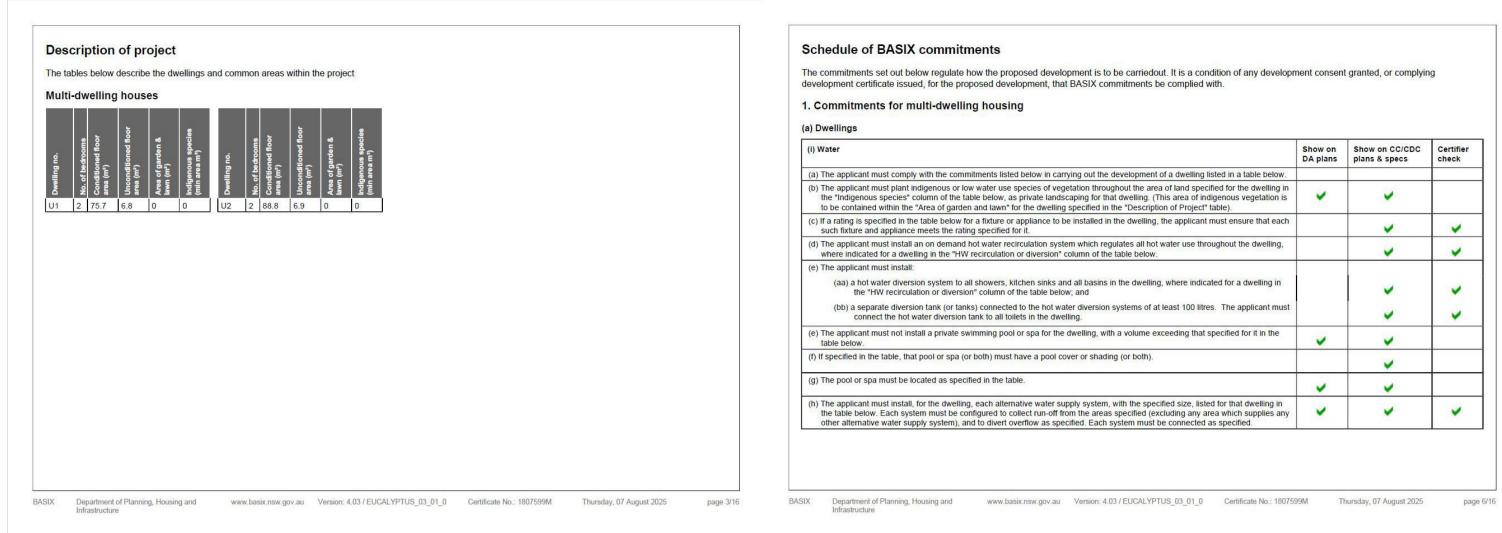






			Fixture	s		Appl	iances		Indiv	idual pool			Inc	dividual :	spa
Dwelling no.	All shower- heads	All toilet flushing systems	All kitchen taps	All bathroom taps	HW recirculation or diversion	All clothes washers	All dish- washers	Volume (max volume)	Pool cover	Pool location	Pool shaded	Volu (max volu		Spa cover	Spa shaded
All dwellings	4 star (> 4.5 but <= 6 L/min)	4 star	4 star	4 star	4	-	-	-	-	-	-	-	-		-
							Alternati	ve water sou	ırce						
Dwelling		rnative wate		Size	Configur	ation			Landso		t ection	Laundry connection		ol top-	Spa top-up
All dwelling	gs No al	ternative wa y	ter	-	-				-	-		-	-		-
(ii) Energ	T-11-11										Show DA p	2.07070	now on C ans & sp		Certifier check
(b) The ap	oplicant mus	st install eac	h hot wate table spe	er system spe cifies a centr	ed below in car ecified for the dv al hot water sys hot water is sup	welling in the	table below, s	that the dw	elling's ho	ot water is		•	~		~
(c) The ap	plicant mus	t install, in e	ach bathr	oom, kitchen	and laundry of nave the operat	the dwelling,	the ventilation	n system spe	cified for t	hat room in			V		V
headir coolin such a	ngs of the "O	cooling" and system is s term "zoned	"Heating" pecified in I" is specif	columns in t	stem/s specified he table below, "Living areas" n air conditionin	in/for at leas or "Bedroom	t 1 living/bedrareas", then r	oom area of too systems m	he dwellir ay be inst	ng. If no called in any			~	0	~
the tal lightin specif	ble below (b g" for each :	ut only to th such room in ticular room	e extent sp the dwell or area, to	pecified for th ling is fluores hen the light	dwelling which nat room or area cent lighting or fittings in that ro	a). The application in the appli	ant must ensu	ire that the "pighting. If the	rimary typ term "dec	oe of artificial dicated" is			~		~
					dwelling which							,	V		-

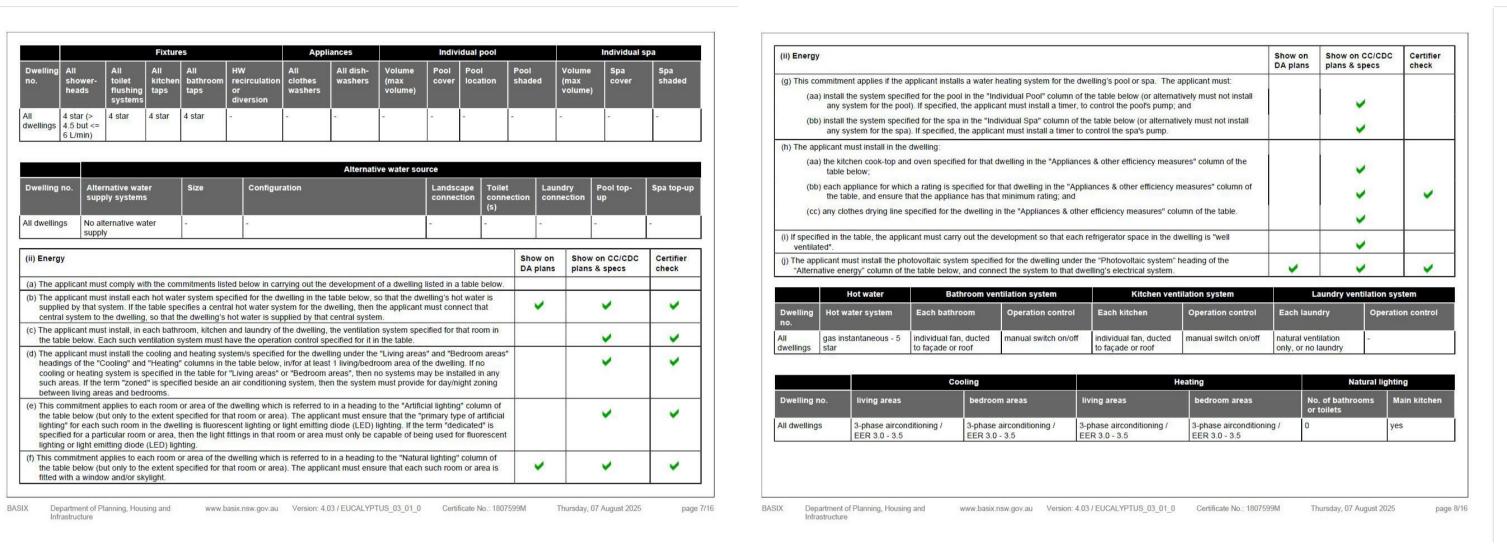


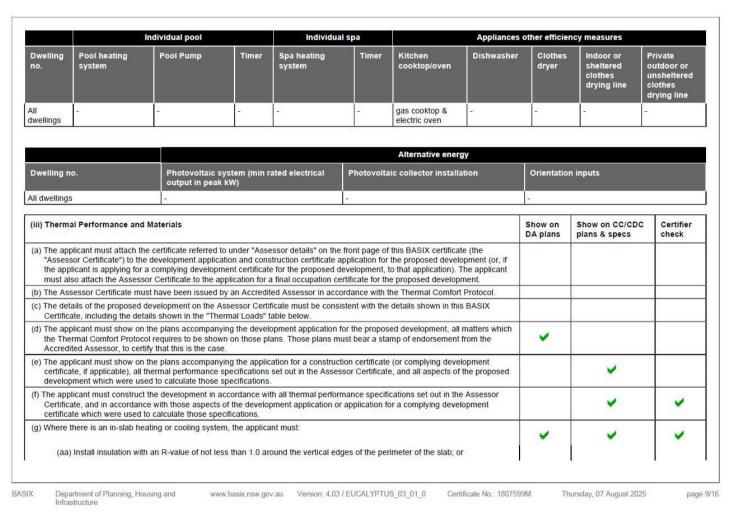

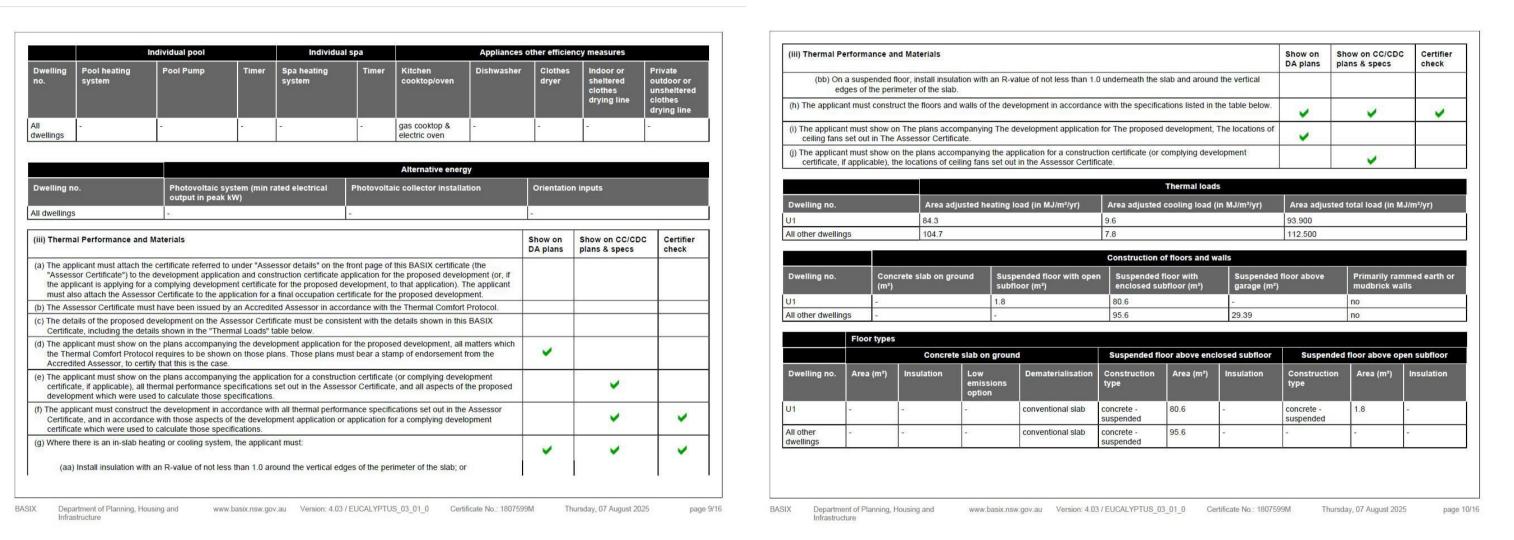

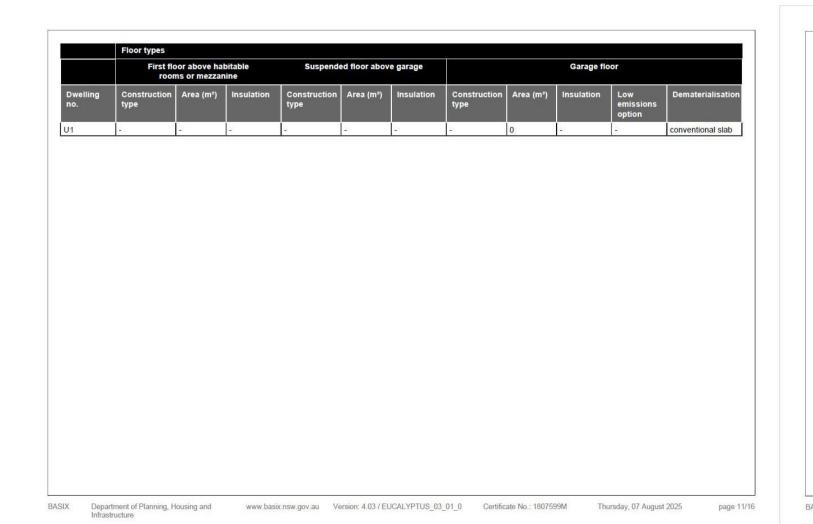

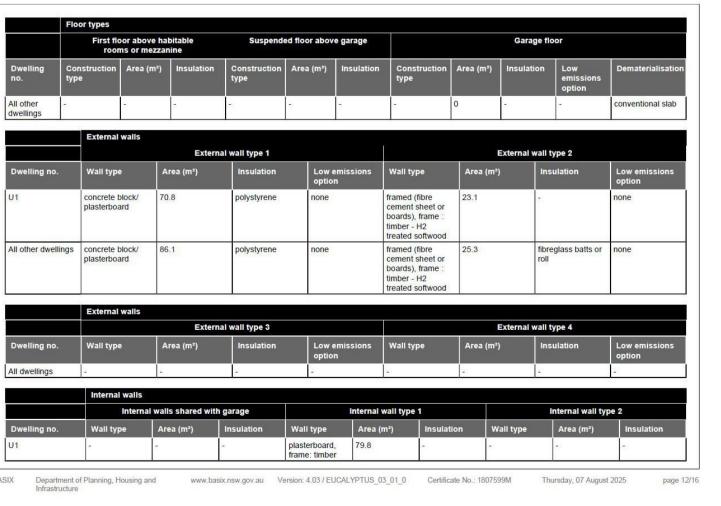

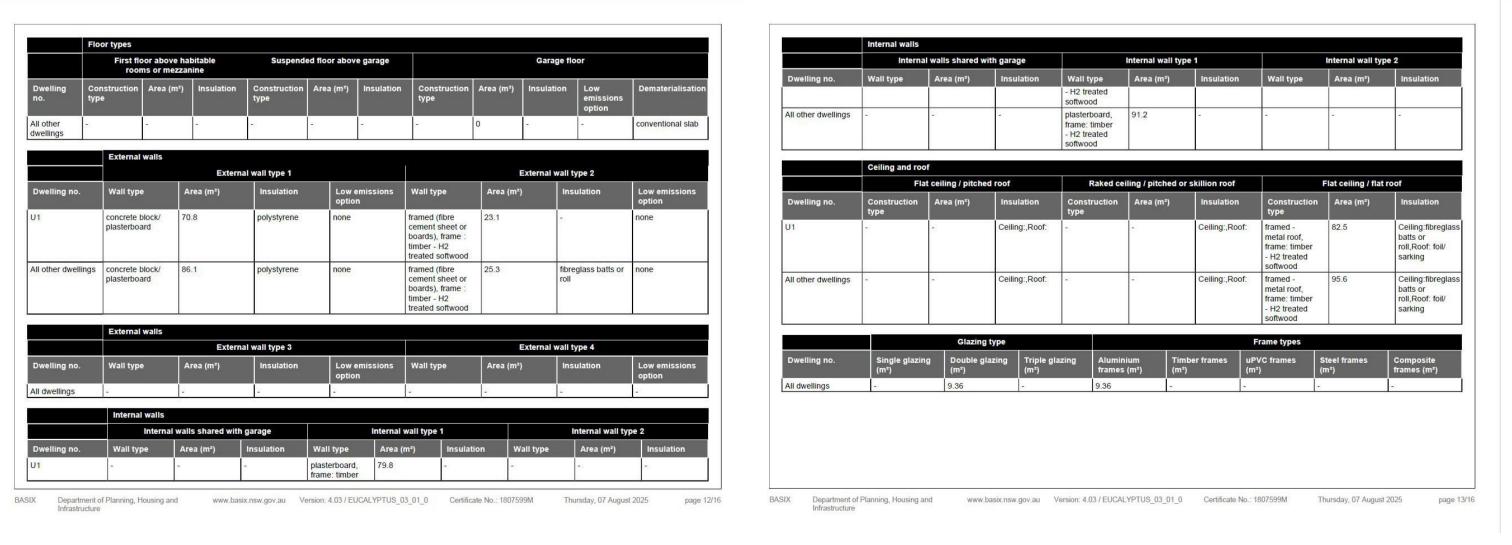

i) Water				Show on DA plans	Show on CC/CDC plans & specs	Certifier check		
	out the development, the applicated for it		or clothes washer into a common area, then tha					
the "Central	The applicant must install (or ensure that the development is serviced by) the alternative water supply system(s) specified in the "Central systems" column of the table below. In each case, the system must be sized, be configured, and be connected, as specified in the table.							
(c) A swimming table.	pool or spa listed in the table mu	st not have a volume (in kLs) greater	r than that specified for the pool or spa in the	~	~			
(d) A pool or spa	a listed in the table must have a c	cover or shading if specified for the p	ool or spa in the table.		V			
(e) The applicar	t must install each fire sprinkler s	system listed in the table so that the	system is configured as specified in the table.		~	~		
(f) The applican	t must ensure that the central coo	oling system for a cooling tower is co	nfigured as specified in the table.		V	~		
Common area	Showerheads rating	Toilets rating	Taps rating	Clothes washer	s rating			
All common ireas	no common facility	no common facility		o common launo				
				Show on DA plans	Show on CC/CDC plans & specs	Certifier check		
(ii) Energy				v.				
(a) If, in carrying			ervice a common area specified in the table below and must meet the efficiency measure specified.	v,	~	~		
(a) If, in carrying then that ver (b) In carrying o in the table t	ntilation system must be of the tylut the development, the applicant below, the lighting specified for the list also install a centralised lighting	pe specified for that common area, a t must install, as the "primary type of at common area. This lighting must i			Ž	~		



NSW REG NO: 9968 ACT REG NO: 2574

Nationwide House Energy Rating Scheme® Multiple Class 1 Dwellings Summary NatHERS® Certificate No. W55HFSSCZM

Generated on 7 Aug 2025 using FirstRate5 v5.5.5a

Property

187 Bourke Street, Goulburn, NSW, 2580

Marios Kardaris

NATIONWIDE

Page 1 of 2

NatHERS Climate Zone



Energy Rating Group admin@energyratinggroup.com.au 0492836228

HERA10132 Assessor Accrediting Organisation HERA

Verification

To verify this certificate, scan the QR code or visit https://www.fr5.co m.au/QRCodeLanding?PublicId=W 55HFSSCZM&GrpCert=1 When using either link, ensure you are visiting www.fr5.com.au.



National Construction Code (NCC) requirements

The NCC allows the use of NatHERS accredited software to comply with the energy efficiency requirements for houses (Class 1 buildings) and apartments (Class 2 sole-occupancy units and Class 4 parts of buildings). The applicable requirements for houses are detailed in Specification 42 of NCC Volume Two. For apartments the requirements are detailed in clauses J3D3 and J3D15 of NCC Volume One.

NCC 2022 includes enhanced thermal performance requirements for houses and apartments. It also includes a new whole-of-home annual energy use budget which applies to the major equipment in the home.

The NCC, and associated ABCB Standards and support material, can be

accessed at www.abcb.gov.au. Note, variations and additions to the NCC energy efficiency requirements may apply in some states and territories.

Summary of all dwellings

Certificate number and link	Unit number	Heating load (load limit) [MJ/m²/p.a.]	Cooling load (load limit) [MJ/m²/p.a.]	Total load [MJ/m²/p.a.]	Star rating	Whole of Home Rating
R181E1JFC5	17/	84.3 (N/A)	9.6 (N/A)	93.9	7.7	NA
CT28CTBEDY	2	104.7 (N/A)	7.8 (N/A)	112.5	7.3	NA

Nationwide House Energy Rating Scheme (NatHERS) is an Initiative of the Australian, state and territory governments. For more details see Generated on 7 Aug 2025 using FirstRate5 v5.5.5a for 187 Bourke Street, Goulburn, NSW, 2580

Nationwide House Energy Rating Scheme® Thermal performance NatHERS® Certificate No. R181E1JFC5

Generated on 8 Jul 2025 using FirstRate5: 5.5.5a (3.22)

Property

Address 1, 187 Bourke Street, Goulburn, NSW, 2580

Lot/DP NCC Class* Class 1a

Floor/all Floors

Plans Main plan 202405

Construction and environment

Kensit Architects

Assessed floor area [m2]* Exposure type Conditioned* suburban Unconditioned* NatHERS climate zone 24 Canberra Airport Total Garage

ccredited assessor

Marios Kardaris Energy Rating Group admin@energyratinggroup.com.au 0492836228

HERA10132 Assessor Accrediting Organisation

NCC Requirements

Declaration of interest

NCC provisions State/Territory variation

National Construction Code (NCC) requirements

The NCC allows the use of NatHERS accredited software to comply with the energy efficiency requirements for houses (Class 1 buildings) and apartments (Class 2 sole-occupancy units and Class 4 parts of buildings). The applicable requirements for houses are detailed in Specification 42 of NCC Volume Two. For apartments the requirements are detailed in clauses J3D3 and J3D15 of NCC Volume One.

NCC 2022 includes enhanced thermal performance requirements for houses and apartments. It also includes a new whole-of-home annual energy use budget which applies to the major equipment in the home.

The NCC, and associated ABCB Standards and support material, can be accessed at www.abcb.gov.au.

Note, variations and additions to the NCC energy efficiency requirements may

Generated on 8 Jul 2025 using FirstRate5: 5.5.5a (3.22) for U 1, 187 Bourke Street, Goulburn , NSW, 2580

apply in some states and territories.

When using either link, ensure you are visiting www.fr5.com.au.



Thermal performance [MJ/m²]

Marios Kardaris Energy Rating Group 0492836228 Accreditation No. HERA10132 (lowest conditioned area) Assessor Accrediting Organisation NCC climate zone 1 or 2

No Whole of Home performance rating generated for this certificate

Verification

Floor type

Outdoor living area

Outdoor living area ceiling fan

Whole of Home

performance rating

To verify this certificate, scan the QR code or visit https://w ww.fr5.com.au/QRCodeLand ing?PublicId=R181E1JFC5



Page 1 of 12



Property

Address

2, 187 Bourke Street, Goulburn , NSW, 2580

Lot/DP NCC Class* Class 1a Floor/all Floors

Plans

202405 Main plan Kensit Architects

Construction and environment

Assessed floor area [m2]* Exposure type Conditioned* suburban Unconditioned* NatHERS climate zone 24 Canberra Airport Total Garage

Accredited assessor

admin@energyratinggroup.com.au

HERA

NCC Requirements

Declaration of interest No

NCC provisions Volume 2 State/Territory variation

National Construction Code (NCC) requirements

The NCC allows the use of NatHERS accredited software to comply with the energy efficiency requirements for houses (Class 1 buildings) and apartments (Class 2 sole-occupancy units and Class 4 parts of buildings). The applicable requirements for houses are detailed in Specification 42 of NCC Volume Two. For apartments the requirements are detailed in clauses J3D3 and J3D15 of NCC Volume One.

NCC 2022 includes enhanced thermal performance requirements for houses and apartments. It also includes a new whole-of-home annual energy use budget which applies to the major equipment in the home

The NCC, and associated ABCB Standards and support material, can be accessed at www.abcb.gov.au.

Note, variations and additions to the NCC energy efficiency requirements may apply in some states and territories.

Thermal performance The more stars the more energy efficient NATIONWIDE **ENERGY RATING SCHEME** 112.5 MJ/m² Predicted annual energy load for

For more information on your dwelling's rating sea: www.nathers.gov.au

heating and cooling based on standard

occupancy assumptions.

Thermal performance [MJ/m²] 7.8

Floor type (lowest conditioned area) NCC climate zone 1 or 2 Outdoor living area N/A

Outdoor living area ceiling fan

Whole of Home performance rating

No Whole of Home performance rating generated for this certificate

Verification

To verify this certificate, scan ww.fr5.com.au/QRCodeLand ing?PublicId=CT28CTBEDY When using either link, ensure you are visiting www.fr5.com.au.



Generated on 8 Jul 2025 using FirstRate5: 5.5.5a (3.22) for U 2, 187 Bourke Street, Goulburn , NSW, 2580

Page 1 of 12

REV DESCRIPTION CONCEPT ISSUE DA DRAFT ISSUE CONSULTANT ISSUE DA ISSUE DA ISSUE

26.05.24

21.04.25

06.07.25

05.08.25

19.08.25

copyright and shall remain the property of Kensit Architects.




KENSIT ARCHITECTS ABN 44 379 363 172 WWW.KENSITARCHITECTS.COM.AU DEAN@KENSITARCHITECTS.COM.AU

PROJECT No.

SHOPTOP HOUSING 5/-/DP778947 [187 BOURKE ST GOULBURN] 202405


DRAWING TITLE BASIX REQUIREMENTS

SCALE DATE AUGUST 2025

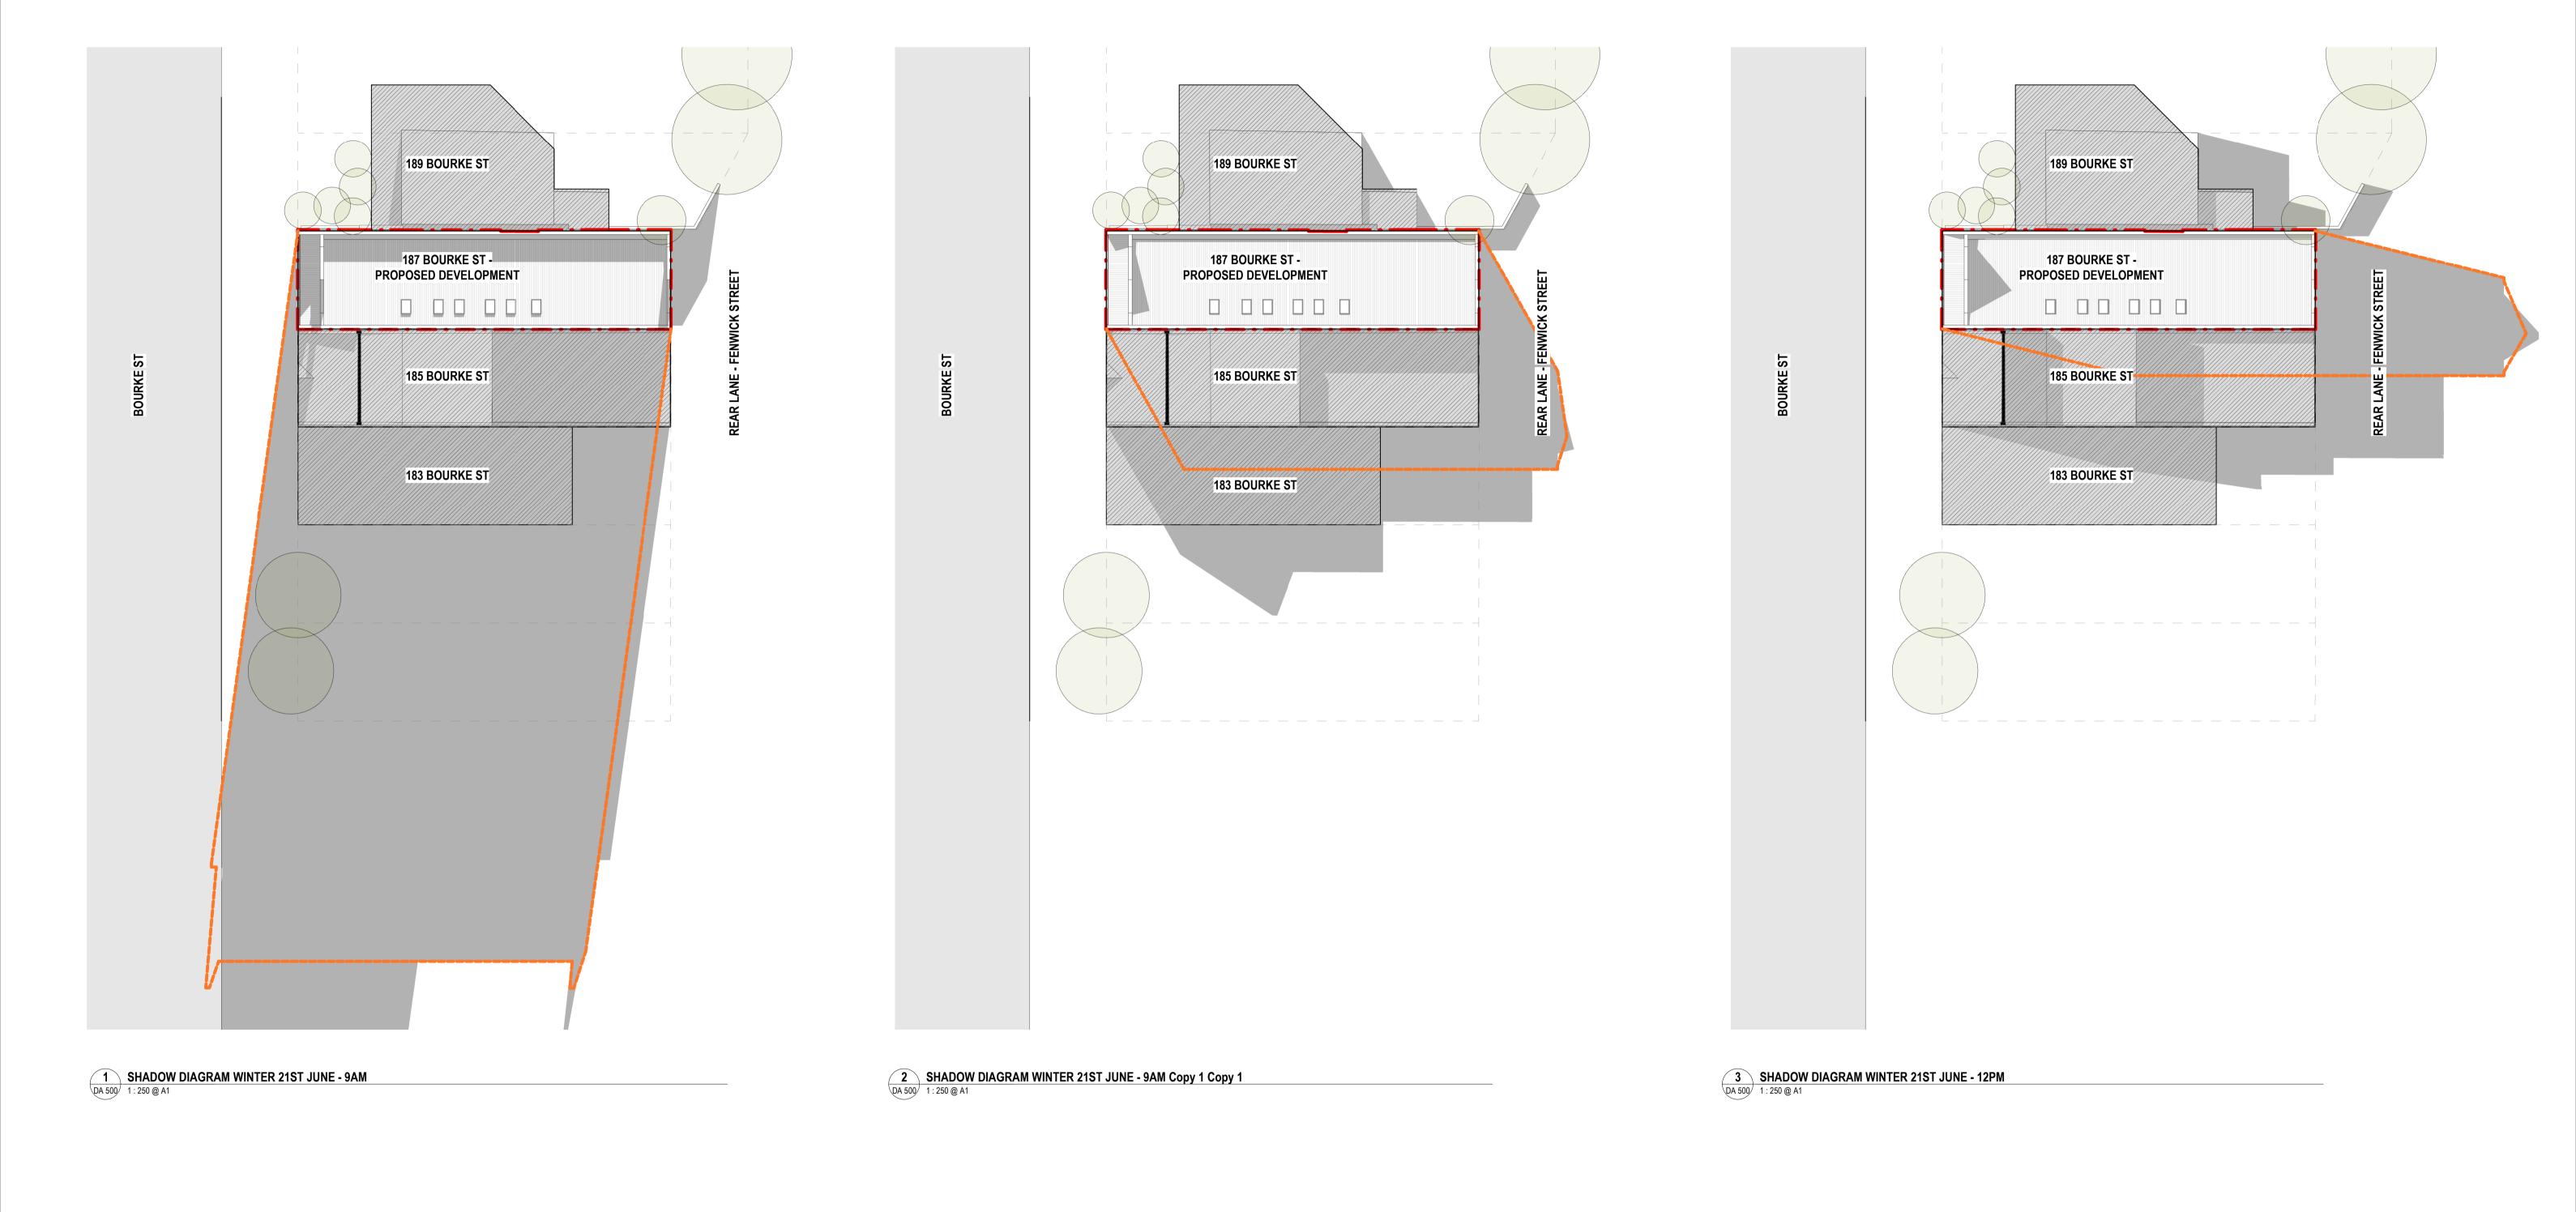

REV DESCRIPTION
A CONCEPT ISSUE
B DA DRAFT ISSUE
C CONSULTANT ISSUE
D DA ISSUE
E DA ISSUE

DATE 26.05.24 21.04.25 06.07.25 05.08.25 19.08.25

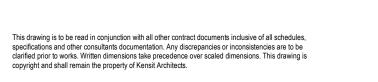



KENSIT ARCHITECTS
ABN 44 379 363 172
WWW.KENSITARCHITECTS.COM.AU
DEAN@KENSITARCHITECTS.COM.AU
PROJECT No.

SHOPTOP HOUSING

5/-/DP778947 [187 BOURKE ST GOULBURN]
202405


DRAWING TITLE SHADOW DIAGRAMS

SCALE 1:250 @ A1

DATE AUGUST 2025

owg DA 500



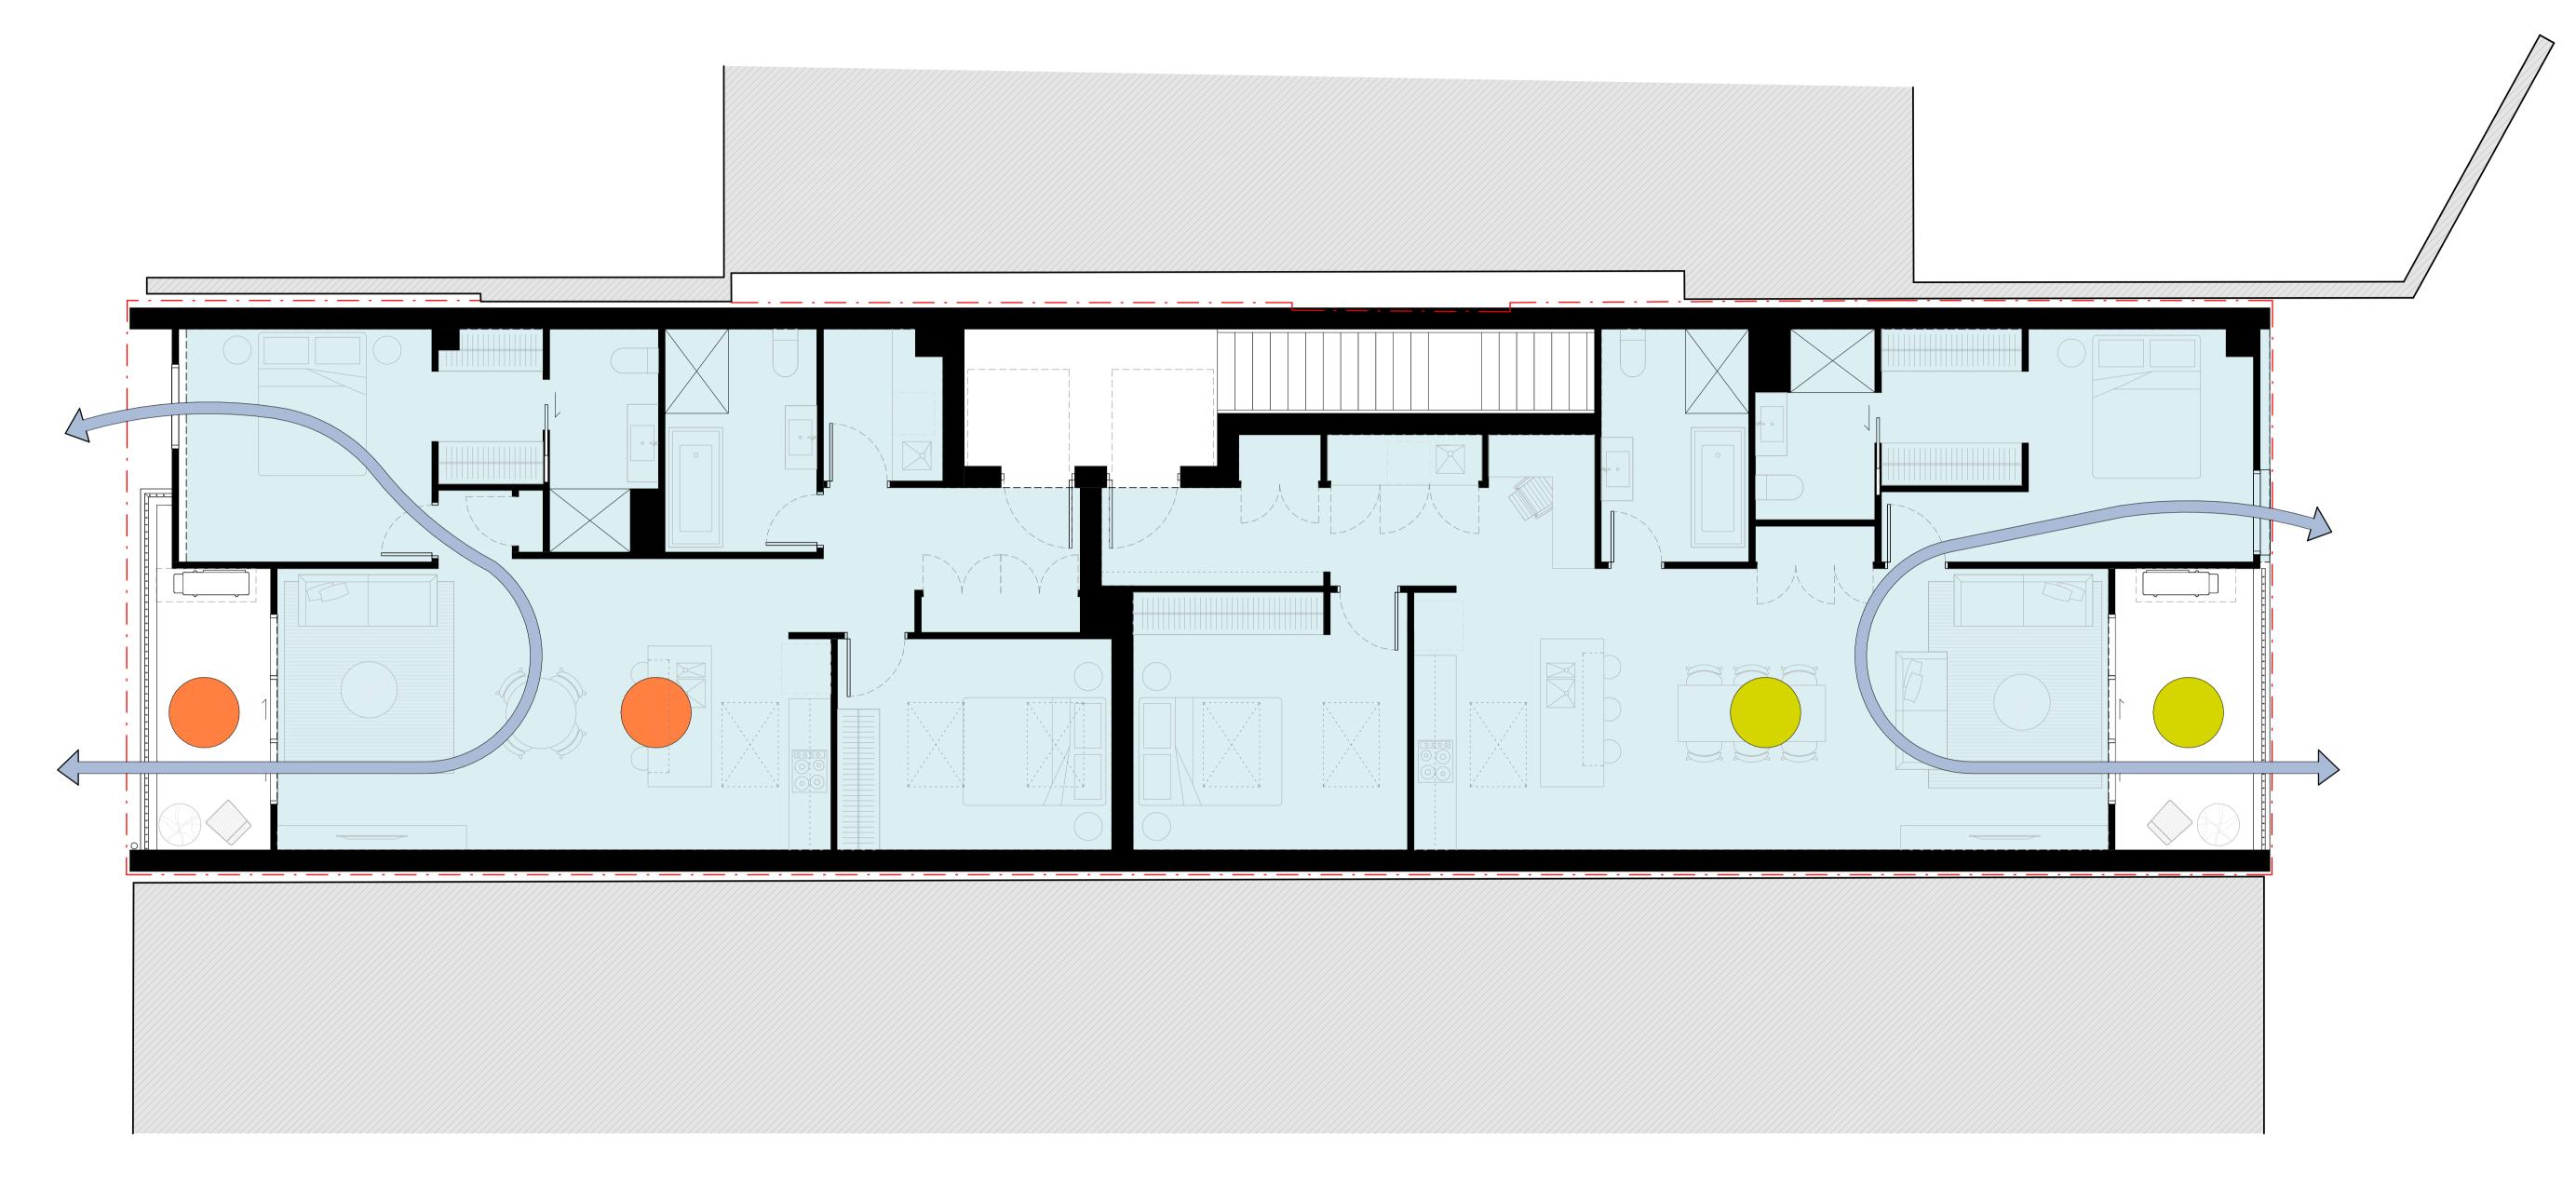

1 RESIDENTIAL - SOLAR ACCESS
1:50 @ A1

SOLAR ACCESS DIAGRAM NOTES


UNIT 1 (FRONT DWELLING):

RECEIVES 3+ HOURS OF DIRECT SUNLIGHT TO LIVING AREAS BETWEEN 9AM-3PM MID-WINTER.

UNIT 2 (REAR DWELLING):

RECEIVES PARTIAL SOLAR ACCESS, SUPPLEMENTED BY SKYLIGHTS TO MEET DAYLIGHT AND AMENITY REQUIREMENTS.

SITE ORIENTATION, BUILT-TO-BOUNDARY NEIGHBOURS, AND FIRE RATING CONSTRAINTS LIMIT DIRECT SUNLIGHT. DESIGN RESPONDS WITH PASSIVE DAYLIGHTING STRATEGIES TO MAINTAIN INTERNAL AMENITY.

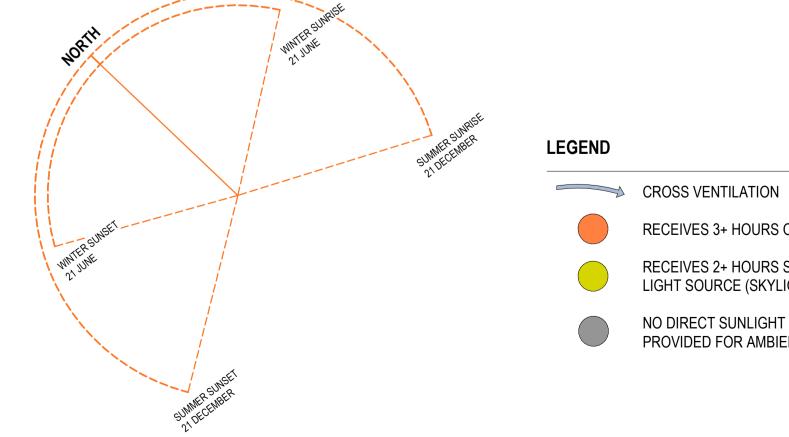

RECEIVES 2+ HOURS SOLAR ACCESS VIA SECONDARY LIGHT SOURCE (SKYLIGHTS)

NO DIRECT SUNLIGHT BETWEEN 9AM-3PM, SKYLIGHT PROVIDED FOR AMBIENT DAYLIGHTING

RECEIVES 3+ HOURS OF DIRECT SOLAR ACCESS

SHOPTOP HOUSING

DRAWING TITLE SOLAR ACCESS

REV DESCRIPTION A CONCEPT ISSUE DA DRAFT ISSUE CONSULTANT ISSUE D DA ISSUE E DA ISSUE

26.05.24 21.04.25 06.07.25 05.08.25 19.08.25

This drawing is to be read in conjunction with all other contract documents inclusive of all schedules, specifications and other consultants documentation. Any discrepancies or inconsistencies are to be clarified prior to works. Written dimensions take precedence over scaled dimensions. This drawing is copyright and shall remain the property of Kensit Architects.



KENSIT ARCHITECTS ABN 44 379 363 172 WWW.KENSITARCHITECTS.COM.AU DEAN@KENSITARCHITECTS.COM.AU

5/-/DP778947 [187 BOURKE ST GOULBURN] PROJECT No. **202405**